


JEFFERSON COUNTY

MISSOURI

JASON JONAS, P.E.
DIRECTOR OF PUBLIC WORKS
HEADS CREEK ROAD
BRIDGE REPLACEMENT
OVER TRIBUTARY TO HEADS CREEK
SECTION 13 TOWNSHIP T42N, RANGE 4E
CDG PROJECT NO. 18013
COUNTY PROJECT NO. PW19135BXC

LOCAL UTILITY COMPANIES	
ELECTRIC	AMEREN MISSOURI
	WILLIAM ROSENER
	6450 HWY MM
	HOUSE SPRINGS, MO 63051
	636-671-6152
	wrosener@ameren.com
TELEPHONE	AT&T DISTRIBUTION
	GLENN HOGENMILLER
	122 NORTH SECOND ST.
	FESTUS, MO 63028
	636-931-7525
	gh5805@att.com
NOTE: NO OTHER KNOWN UTILITIES UTILITY LOCATE: 1-800-DIG-RITE	

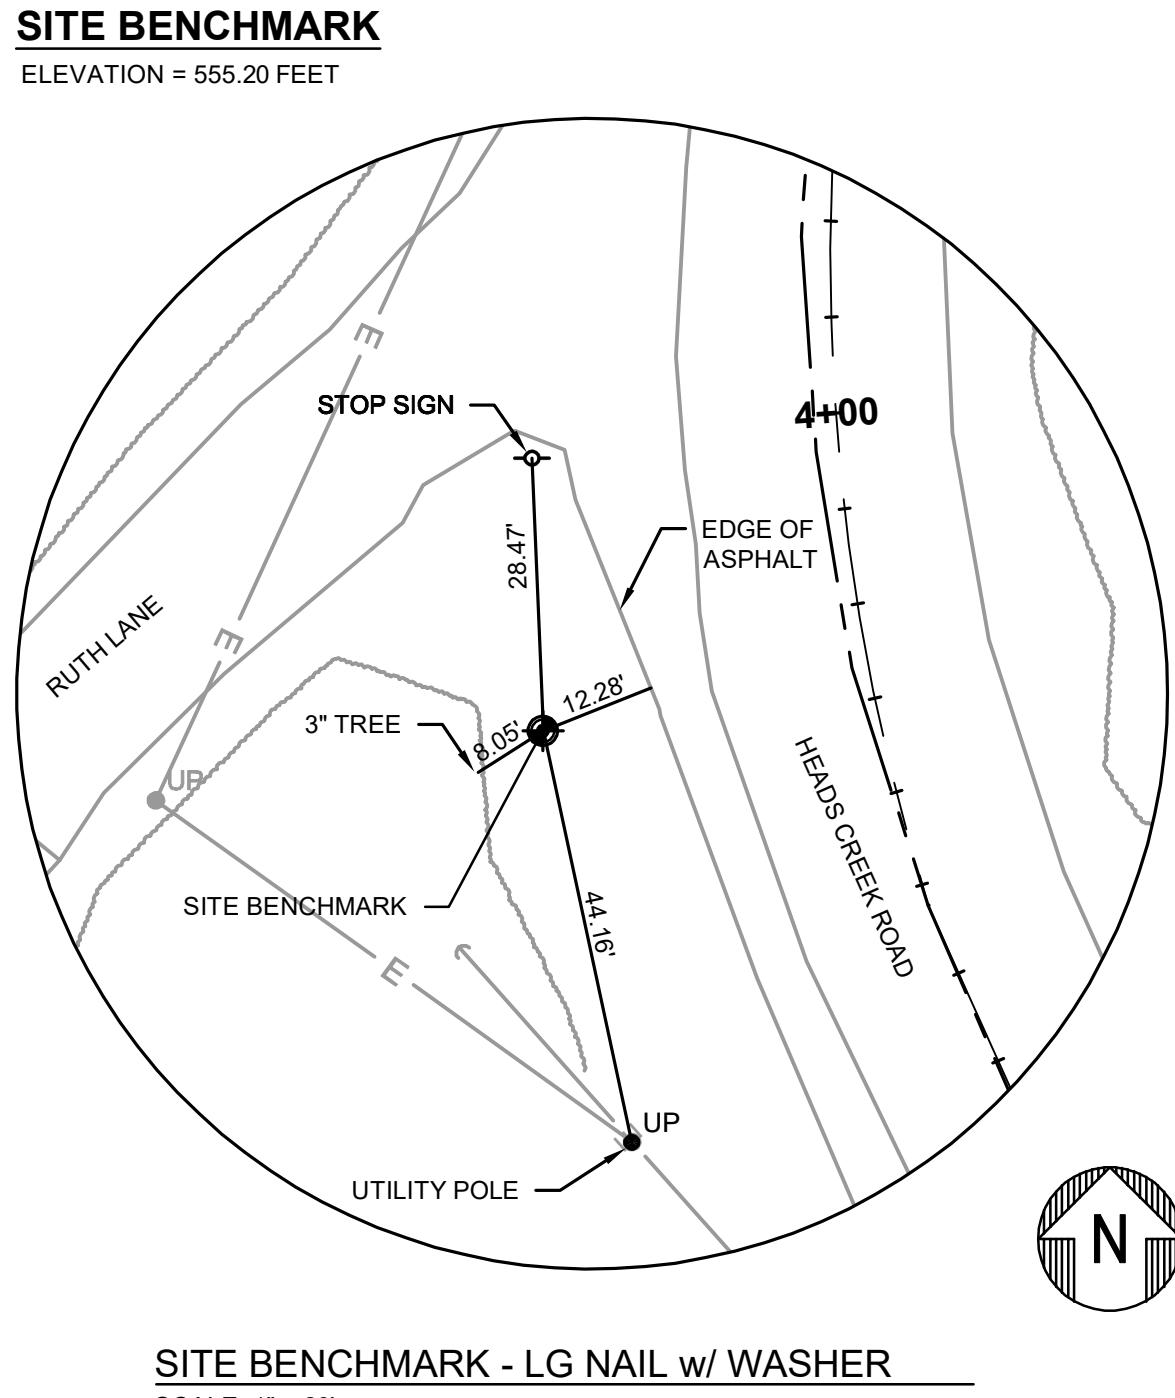

BENCHMARK DATA

SITE BENCHMARK
LARGE NAIL w/ WASHER
ELEVATION - 555.20 (NAVD 88 DATUM)

THE LARGE NAIL IS SET ON THE RIGHT SHOULDER OF HEADS CREEK ROAD BETWEEN RUTH LANE AND HEADS CREEK ROAD; WITHIN THE GRASS AREA, WHICH IS LOCATED APPROXIMATELY 138.00 FEET SOUTH OF THE BOX CULVERT.

VERTICAL CONTROL STATEMENT

THE ELEVATIONS SHOWN HEREON ARE BASED ON THE NORTH AMERICAN VERTICAL DATUM OF 1988 (NAVD88).

HORIZONTAL CONTROL STATEMENT

THE DATA SHOWN HEREON WAS TIED TO THE NATIONAL GEODETIC SURVEY (NGS) CONTINUOUSLY OPERATING REFERENCE STATION (CORS) NETWORK USING REAL TIME KINEMATIC GPS METHODS. GPS DATA BASED ON THE MODOT GNSS NETWORK SERVICE OPERATED BY MODOT WITHIN THE 1983 EAST ZONE (NAD83).

THE SITE GPS SCALE FACTOR IS 0.999916630


LEGEND:

● = SITE BENCHMARK

N: = NORTHING COORDINATE

E: = EASTING COORDINATE

FINAL PLANS

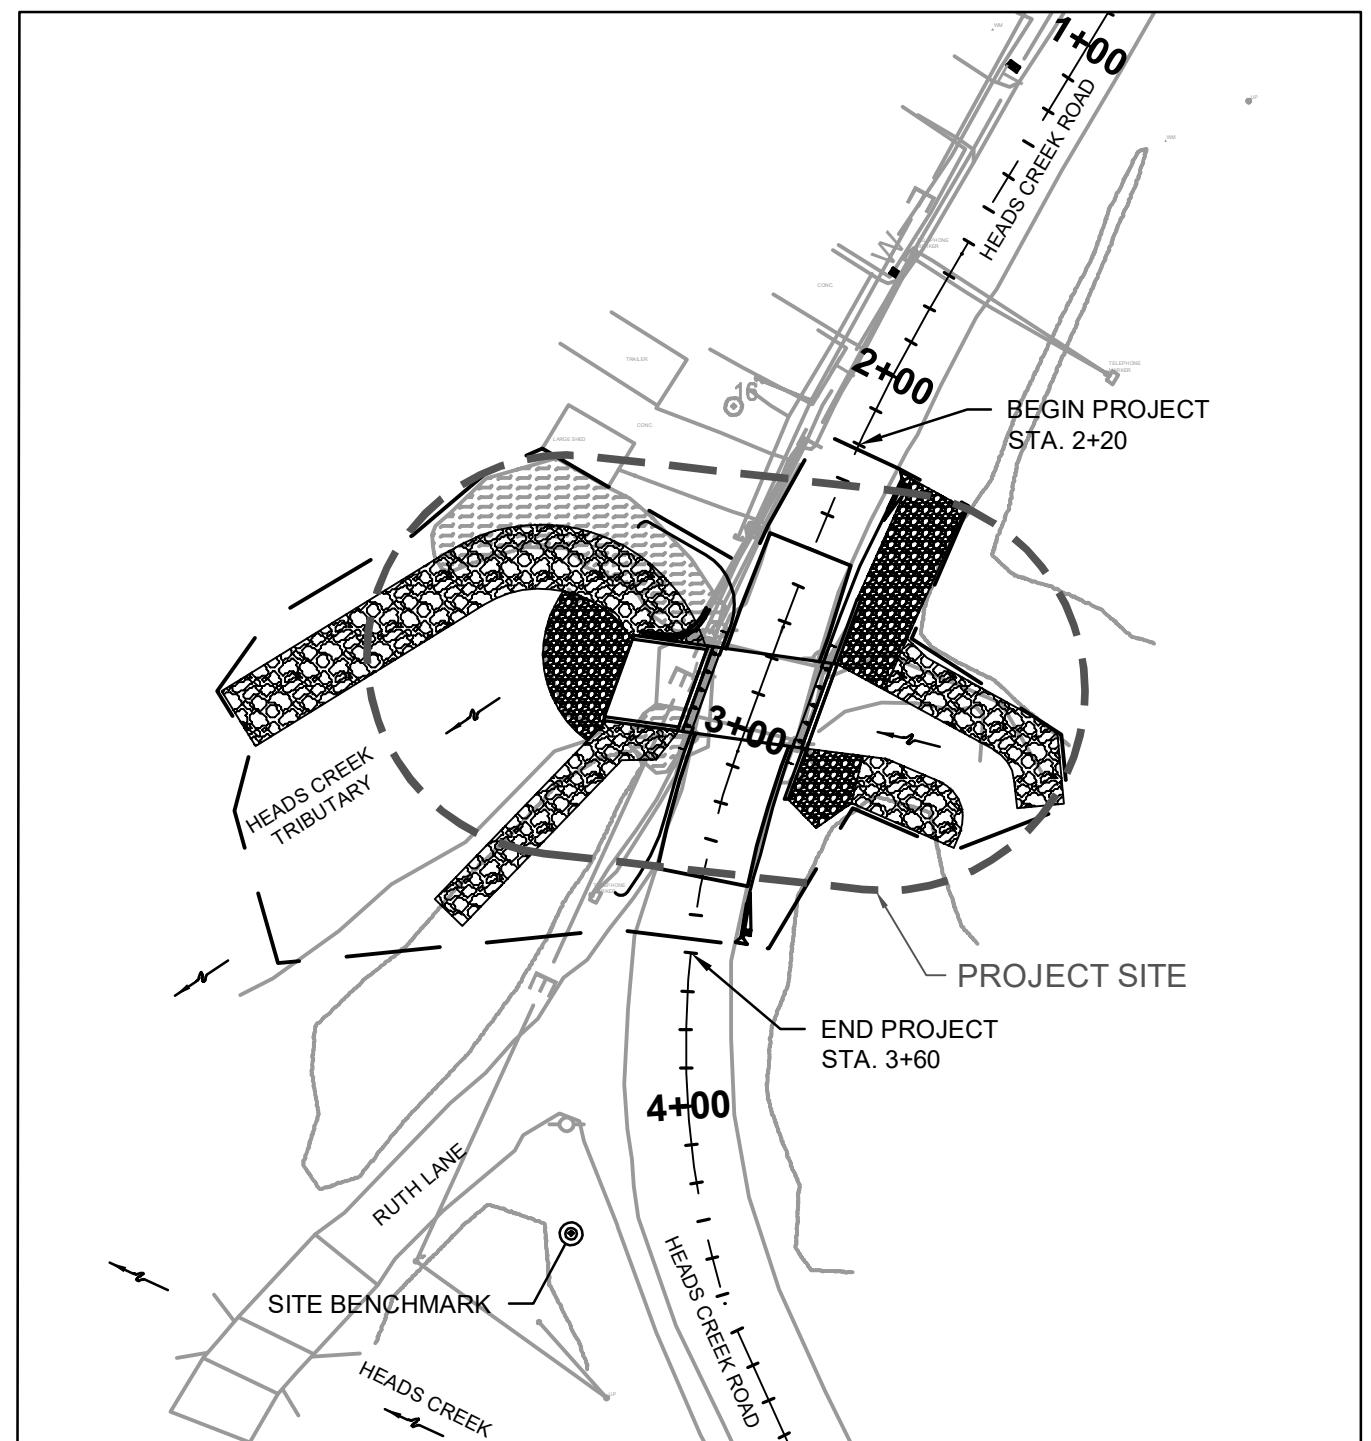

PROJECT SITE MAP
SCALE: 1" = 1:50'

PLOT SCALE FACTOR 1

THE UNDERGROUND UTILITIES SHOWN HEREIN WERE PLOTTED FROM AVAILABLE INFORMATION AND DO NOT NECESSARILY REFLECT THE ACTUAL EXISTENCE, NONEXISTENCE, SIZE, TYPE, NUMBER, OR LOCATION OF THESE OR OTHER UTILITIES. THE GENERAL CONTRACTOR SHALL BE RESPONSIBLE FOR VERIFYING THE ACTUAL LOCATION OF ALL UNDERGROUND UTILITIES, SHOWN OR NOT SHOWN, AND SHALL LOCATE THE UTILITIES IN THE FIELD PRIOR TO ANY GRADING, EXCAVATION, OR CONSTRUCTION IMPROVEMENTS.

DESIGN CRITERIA

1. A POLICY ON GEOMETRIC DESIGN OF HIGHWAYS AND STREETS (AASHTO "GREEN BOOK" EDITION 2011)
2. 2018 MISSOURI STANDARD SPECIFICATIONS FOR HIGHWAY CONSTRUCTION
3. MANUAL ON UNIFORM TRAFFIC CONTROL DEVICES (MUTCD) EDITION 2009
4. MODOT ENGINEERING POLICY GUIDE

DESIGN DESIGNATION


FUNCTIONAL CLASSIFICATION	LOCAL / RURAL COLLECTOR
CURRENT POSTED SPEED	30 MPH
DESIGN SPEED	30 MPH

LENGTH OF PROJECT

BEGINNING STATION	2+20
ENDING STATION	3+60
NET LENGTH OF PROJECT	140 FEET (0.02 MI)


SHEET INDEX

DRAWING NUMBER	DESCRIPTION
ROADWAY	TITLE SHEET
T-001	GENERAL NOTES
T-002	SUMMARY OF QUANTITY (2A & 2B)
T-003	CULVERT PLAN & PROFILE
C-101	Typical Details
C-301	SITE GRADING PLAN
C-401	DETOUR PLAN
C-501	RIGHT-OF-WAY PLAN
R-101	
BRIDGE	GENERAL PLAN & ELEVATION
B-101	CULVERT PLAN, ELEVATIONS & SECTIONS
B-102	CULVERT ELEVATION & DETAILS
B-103	RETAINING WALL NO. 1
B-104	RETAINING WALL NO. 2
B-105	CULVERT PLAN - BOTTOM SLAB REINFORCEMENT
B-106	CULVERT PLAN - TOP SLAB REINFORCEMENT
B-107	BRIDGE GUARDRAIL W-BEAM DETAILS
B-108	BILL OF REINFORCING STEEL
B-109	

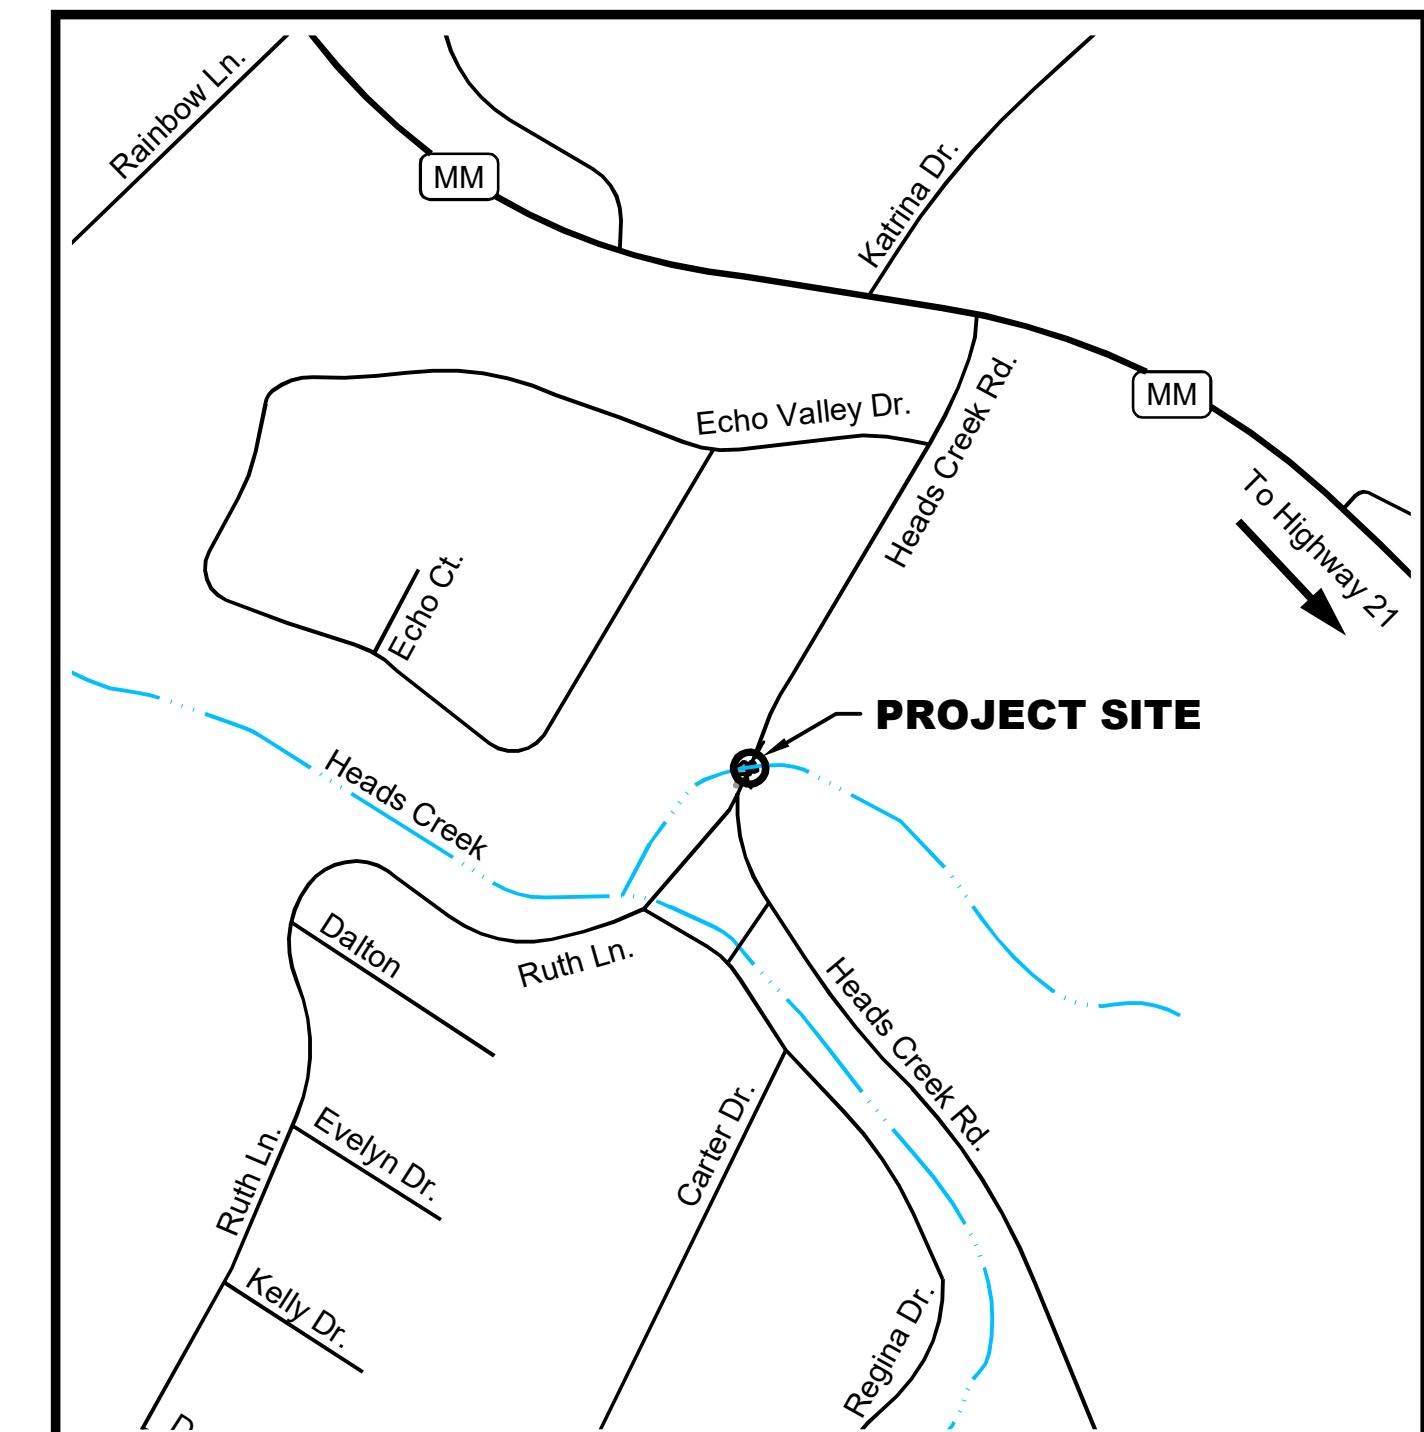

APPROVED BY
JEFFERSON COUNTY, MISSOURI
1-23-2019
DATE
JASON JONAS, P.E.
DIRECTOR OF PUBLIC WORKS


REV.	DATE	DESCRIPTION	APPROVED
0	01/22/19	ISSUED FOR CONSTRUCTION	TRN

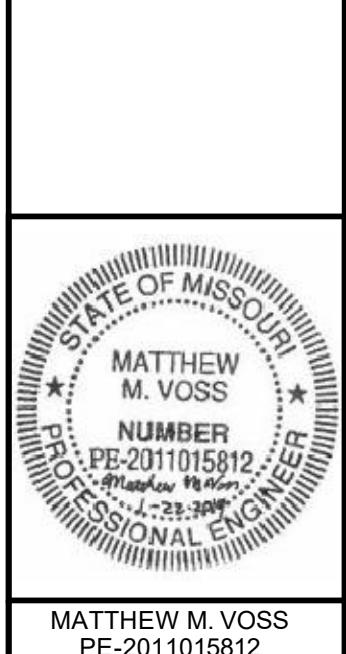

Trugent
January 28, 2019

COVER SHEET
COUNTY PROJECT NO. PW19135BXC
HEADS CREEK ROAD BRIDGE
JEFFERSON COUNTY, MISSOURI

CDG PROJECT NO.
18013
DRAWING NO.
T-001

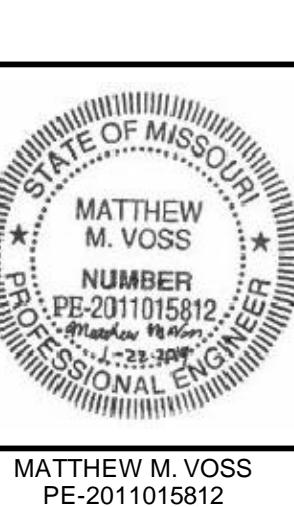

STATE OF MISSOURI
MATTHEW M. VOSS
NUMBER PE-201105812
PROFESSIONAL ENGINEER
J-25-309

M. Voss
January 22, 2019

GENERAL NOTES
COUNTY PROJECT NO. PW19135BXC
HEADS CREEK ROAD BRIDGE
JEFFERSON COUNTY, MISSOURI

GENERAL NOTES:

1. REMOVE ALL WASTE MATERIALS, INCLUDING EXCAVATED MATERIAL, TRASH, AND DEBRIS, AND DISPOSE OF IT PROPERLY OFF-SITE.
2. CONTRACTOR SHALL REPLACE ALL FENCES, SIGNS, ETC. DAMAGED BY THIS CONSTRUCTION. PROVIDE PROTECTION NECESSARY TO PREVENT DAMAGE TO EXISTING CONDITIONS, TREES, ETC.
3. CONTRACTOR SHALL COORDINATE AND COOPERATE WITH OTHER CONTRACTORS AND OTHER COUNTY MAINTENANCE CREWS PERFORMING ROAD WORK.
4. A COPY OF ALL LOAD TICKETS SHALL BE TURNED IN DAILY TO THE DIRECTOR OF PUBLIC WORKS OR THE DIRECTOR OF PUBLIC WORKS DESIGNATED REPRESENTATIVE.
5. CATCHLINES APPROXIMATE LIMITS OF DISTURBANCE.
6. SAWCUT EXISTING PAVEMENT (FULL DEPTH) AS NECESSARY TO INSTALL PROPOSED IMPROVEMENTS WITH 1' MAXIMUM OVERDIG. (COST INCIDENTAL TO OTHER ITEMS).

INFORMATION ON SITE CONDITIONS:

1. GENERAL: INFORMATION OBTAINED BY THE OWNER REGARDING SITE CONDITIONS, TOPOGRAPHY AND SUBSURFACE INFORMATION OBTAINED BY THE ENGINEER'S INVESTIGATION OF SURFACE AND SUBSURFACE CONDITIONS, SHALL BE CONSIDERED PART OF THE CONTRACT DOCUMENTS. NEITHER THE ENGINEER NOR THE COUNTY ASSUMES ANY RESPONSIBILITY FOR ITS ACCURACY OR COMPLETENESS OR FOR THE INTERPRETATION OF SUCH INFORMATION.
2. EXISTING ELEVATIONS: ELEVATIONS ARE EXPECTED TO VARY +/- 0.1 FEET FROM THE ELEVATIONS SHOWN. THE COUNTY SHALL VERIFY EXISTING ELEVATIONS PRIOR TO START OF NEW WORK.

EXISTING UTILITIES AND FACILITIES:

1. THE UNDERGROUND UTILITIES SHOWN HEREIN WERE PLOTTED FROM AVAILABLE INFORMATION AND DO NOT NECESSARILY REFLECT THE ACTUAL EXISTENCE, NONEXISTENCE, SIZE, TYPE, NUMBER, OR LOCATION OF THESE OR OTHER UTILITIES. THE CONTRACTOR SHALL BE RESPONSIBLE FOR THE VERIFYING THE ACTUAL LOCATION OF ALL UNDERGROUND UTILITIES, SHOWN OR NOT SHOWN, AND SHALL LOCATE THE UTILITIES IN THE FIELD PRIOR TO ANY GRADING, EXCAVATION, OR CONSTRUCTION IMPROVEMENTS.
2. CONTRACTOR TO NOTIFY AND COORDINATE WITH UTILITY COMPANIES TWO WEEKS PRIOR TO COMMENCEMENT OF PROJECT.
3. ALL UTILITIES, EITHER SHOWN OR NOT SHOWN, IN DIRECT CONFLICT WITH THIS CONSTRUCTION SHALL BE RELOCATED BY OTHERS (RESPECTIVE UTILITY COMPANY). CONTRACTOR SHALL COORDINATE THE WORK WITH EACH UTILITY COMPANY AFFECTED.
4. CONTRACTOR TO VERIFY LOCATIONS OF ALL GAS AND WATER SERVICE VALVES, SEWER VENTS, AND WATER METERS BEFORE BEGINNING WORK.
5. CONTRACTOR TO VERIFY THE EXISTENCE OF ANY CABLE AND ALL OTHER UTILITY SYSTEMS BEFORE COMMENCING WORK.
6. CONTRACTOR TO COORDINATE THE ADJUSTMENT OF UTILITY MAIN LINE VALVE COVERS WITH THE CORRESPONDING UTILITY OWNER. THIS WORK SHALL BE CONSIDERED INCIDENTAL TO THE CONTRACT.
7. ALL POWER POLES WITHIN THE LIMITS OF DISTURBANCE TO BE USED IN PLACE.
8. KNOWN UTILITIES AND FACILITIES ADJACENT TO OR WITHIN THE WORK AREA ARE SHOWN ON THE DRAWINGS. THE LOCATIONS SHOWN ARE TAKEN FROM EXISTING RECORDS AND THE BEST INFORMATION AVAILABLE FROM EXISTING UTILITY PLANS; HOWEVER, IT IS EXPECTED THAT THERE MAY BE SOME DISCREPANCIES AND OMISSIONS IN THE LOCATIONS AND QUANTITIES SHOWN. THOSE SHOWN ARE FOR THE CONVENIENCE OF THE CONTRACTOR ONLY, AND NO RESPONSIBILITY IS ASSUMED BY EITHER THE OWNER OR THE ENGINEER FOR THEIR ACCURACY OR COMPLETENESS.
9. NEITHER OWNER NOR ITS OFFICERS OR AGENTS SHALL BE RESPONSIBLE TO CONTRACTOR FOR DAMAGES AS A RESULT OF THE CONTRACTOR'S FAILURE TO PROTECT UTILITIES ENCOUNTERED IN THE WORK.
10. CONTRACTOR SHALL EXERCISE REASONABLE CARE AND COORDINATE WITH THE COUNTY AND THE UTILITY COMPANY TO VERIFY LOCATIONS OF UTILITIES AND FACILITIES SHOWN ON THE DRAWINGS AND TO DETERMINE THE PRESENCE OF THOSE NOT SHOWN. IMMEDIATE AND ADJACENT AREAS WHERE EXCAVATIONS ARE TO BE MADE SHALL BE THOROUGHLY CHECKED BY VISUAL EXAMINATION FOR INDICATIONS OF UNDERGROUND FACILITIES, AND ALSO CHECKED WITH ELECTRONIC METAL AND PIPE DETECTION EQUIPMENT. WHERE THERE IS REASONABLE CAUSE TO VERIFY THE PRESENCE OR ABSENCE OF AN UNDERGROUND FACILITY, MAKE EXPLORATORY EXCAVATIONS PRIOR TO PROCEEDING WITH MAJOR EXCAVATION IN THE AREA.
11. CONTRACTOR IS RESPONSIBLE FOR COMPLIANCE WITH ALL ASPECTS OF MISSOURI UNDERGROUND FACILITY SAFETY AND DAMAGE PREVENTION STATUTE RSMO 319.015 TO 319.050. CALL 1-800-DIG-RITE.

PRECONSTRUCTION SURVEY AND MONITORING:

1. AFTER THE CONTRACT IS AWARDED AND BEFORE STARTING THE WORK, THE CONTRACTOR SHALL PERFORM A PRECONSTRUCTION SURVEY OF THE SITE. MAKE A THOROUGH EXAMINATION, PROVIDING COLOR PHOTOGRAPHS AND A COLOR VIDEO OF ALL EXISTING BUILDINGS, STRUCTURES AND OTHER IMPROVEMENTS WHICH MIGHT BE DAMAGED BY THE CONTRACTOR'S OPERATIONS. THE EXAMINATION SHALL BE MADE JOINTLY BY REPRESENTATIVES OF THE CONTRACTOR, THE OWNER, AND THE ENGINEER. THE SCOPE OF THE EXAMINATION AND PHOTOGRAPHS SHALL INCLUDE CRACKS IN STRUCTURES, SETTLEMENT, LEAKAGE, AND SIMILAR CONDITIONS. THE COUNTY SHALL BE RESPONSIBLE FOR ELECTRONIC DOCUMENTATION OF THE PRECONSTRUCTION SURVEY, INCLUDING VIDEO, PHOTOS, ETC.
2. THE CONTRACTOR SHALL ESTABLISH VERTICAL AND HORIZONTAL SURVEY CONTROL POINTS ON ALL STRUCTURES AND IMPROVEMENTS LOCATED IN THE VICINITY OF THE WORK PRIOR TO BEGINNING WORK. THE CONTRACTOR SHALL FURNISH THE COUNTY WITH COPIES OF THE SURVEY NOTES FOR EACH SURVEY AND A COPY OF THE LAYOUT OF THE SURVEY CONTROL POINTS.
3. COPIES OF ALL ELECTRONIC DOCUMENTATION SHALL BE PROVIDED TO THE OWNER AND THE ENGINEER.
4. THE ABOVE RECORDS AND PHOTOGRAPHS ARE INTENDED FOR USE AS EVIDENCE IN ASCERTAINING THE EXTENT OF ANY DAMAGE WHICH MAY OCCUR AS A RESULT OF THE CONTRACTOR'S OPERATIONS AND ARE FOR THE PROTECTION OF THE CONTRACTOR AND THE OWNER. THE RECORDS WILL PROVIDE A MEANS OF DETERMINING WHETHER AND TO WHAT EXTENT DAMAGE MAY HAVE OCCURRED AS A RESULT OF THE CONTRACTOR'S OPERATIONS. THE RECORDS WILL ALSO BE UTILIZED TO GUIDE THE RESTORATION PHASE OF THIS PROJECT.

CONTRACTOR'S RESPONSIBILITIES:

1. WHERE CONTRACTOR'S OPERATIONS COULD CAUSE DAMAGE OR INCONVENIENCE TO RAILWAY OR PUBLIC/PRIVATE UTILITY SYSTEMS, THE CONTRACTOR SHALL MAKE ARRANGEMENTS NECESSARY FOR THE PROTECTION OF THESE UTILITIES AND SERVICES. REPAIR OR REPLACE EXISTING UTILITIES REMOVED OR DAMAGED DURING CONSTRUCTION, UNLESS OTHERWISE PROVIDED FOR IN THESE CONTRACT DOCUMENTS.
2. NOTIFY UTILITY OFFICES THAT ARE AFFECTED BY CONSTRUCTION OPERATIONS AT LEAST 72 HOURS IN ADVANCE. UNDER NO CIRCUMSTANCES SHALL ANY UTILITY BE EXPOSED WITHOUT FIRST OBTAINING PERMISSION FROM THE APPROPRIATE AGENCY. ONCE PERMISSION HAS BEEN GRANTED, LOCATE, EXPOSE, AND PROVIDE TEMPORARY SUPPORT FOR THE UTILITIES AS REQUIRED.
3. CONTRACTOR SHALL BE SOLELY AND DIRECTLY RESPONSIBLE TO OWNER AND OPERATOR OF SUCH PROPERTIES FOR DAMAGE, INJURY, EXPENSE, LOSS, INCONVENIENCE, DELAY, SUITS, ACTIONS, OR CLAIMS OF ANY CHARACTER BROUGHT BECAUSE OF INJURIES OR DAMAGE WHICH MAY RESULT FROM CONSTRUCTION OPERATIONS UNDER THIS CONTRACT.
4. IN EVENT OF INTERRUPTION TO DOMESTIC WATER, SEWER, STORM DRAIN, OR OTHER UTILITY SERVICES AS A RESULT OF ACCIDENTAL DAMAGE DUE TO CONSTRUCTION OPERATIONS, PROMPTLY NOTIFY THE PROPER AUTHORITY. COOPERATE WITH SAID AUTHORITY IN RESTORATION AS PROMPTLY AS POSSIBLE AND PAY FOR REPAIR.
5. IN THE EVENT THE CONTRACTOR ENCOUNTERS WATER SERVICE LINES THAT INTERFERE WITH TRENCHING, OBTAIN PRIOR APPROVAL OF THE WATER UTILITY, CUT THE SERVICE, DIG THROUGH, AND RESTORE SERVICE TO PREVIOUS CONDITIONS USING EQUAL MATERIALS.

INTERFERING STRUCTURES:

1. TAKE NECESSARY PRECAUTIONS TO PREVENT DAMAGE TO EXISTING STRUCTURES TO REMAIN WHETHER ON THE SURFACE, ABOVEGROUND, OR UNDERGROUND. AN ATTEMPT HAS BEEN MADE TO SHOW MAJOR STRUCTURES ON THE DRAWINGS. WHILE THE INFORMATION HAS BEEN COMPILED FROM THE BEST AVAILABLE SOURCES, ITS COMPLETENESS AND ACCURACY CANNOT BE GUARANTEED.
2. PROTECT EXISTING STRUCTURES TO REMAIN FROM DAMAGE, WHETHER OR NOT THEY LIE WITHIN LIMITS OF EASEMENTS OBTAINED BY THE OWNER. WHERE EXISTING FENCES, GATES, BARNs, SHEDs, BUILDINGS, OR OTHER STRUCTURE MUST BE REMOVED TO PROPERLY CARRY OUT WORK, OR ARE DAMAGED DURING THE WORK, RESTORE THEM TO ORIGINAL CONDITION AND TO THE SATISFACTION OF PROPERTY OWNER.
3. CONTRACTOR MAY REMOVE AND REPLACE IN EQUAL OR BETTER THAN ORIGINAL CONDITION, SMALL STRUCTURES SUCH AS FENCES, AND SIGNPOSTS THAT INTERFERE WITH CONTRACTOR'S OPERATIONS. THIS WORK SHALL BE COORDINATED WITH THE OWNER. THIS WORK SHALL BE INCIDENTAL TO THE PROJECT.
4. THE CONTRACTOR SHALL BE RESPONSIBLE FOR LOCATING AND PROTECTING IRRIGATION SYSTEMS. SYSTEMS DAMAGED BY THE COUNTY CREW SHALL BE REPAIRED WITHIN FIVE (5) DAYS.
5. THE CONTRACTOR SHALL BE RESPONSIBLE FOR LOCATING AND PROTECTING ELECTRONIC DOG FENCES. FENCES DAMAGED BY THE COUNTY CREW SHALL BE REPAIRED WITHIN FIVE (5) DAYS.
6. MAILBOXES SHALL BE MOVED TO A NEW LOCATION AND KEPT IN OPERATION DURING CONSTRUCTION. MAILBOXES SHALL BE RESTORED TO THEIR ORIGINAL LOCATION OR A SUITABLE PERMANENT LOCATION AFTER CONSTRUCTION OF NEW PAVEMENT. THIS WORK SHALL BE INCIDENTAL TO THE PROJECT. NO DIRECT PAYMENT WILL BE MADE FOR THIS WORK.
7. EXISTING TREES TO REMAIN SHALL BE PROTECTED AT ALL TIMES. DAMAGED TREES SHALL BE REPAIRED OR REPLACED IN ACCORDANCE WITH COUNTY INSTRUCTIONS.
8. ANY EXISTING SIGNS WHICH MAY INTERFERE WITH CONSTRUCTION ACTIVITIES MAY BE REMOVED AND SHALL BE REPLACED AFTER PROJECT COMPLETION AT THE CONTRACTOR'S EXPENSE. SIGNAGE IS TO BE APPROVED BY THE COUNTY.
9. CONTRACTOR IS RESPONSIBLE FOR REMOVAL, PROTECTION, AND FINAL PLACEMENT OF ALL EXISTING SIGNAGE WITHIN THE LIMITS OF THIS PROJECT. ALL EXISTING SIGNAGE SHALL BE RE-ERECTED IN ITS ORIGINAL LOCATION UNLESS OTHERWISE DIRECTED BY THE COUNTY. SIGNS DAMAGED DURING CONSTRUCTION SHALL BE REPLACED TO THE COUNTY'S SATISFACTION AT THE CONTRACTOR'S EXPENSE. CONTRACTOR SHALL BE RESPONSIBLE FOR DOCUMENTATION OF CONDITIONS OF SIGNS BEFORE CONSTRUCTION BEGINS. THIS WORK SHALL BE INCIDENTAL TO THE PROJECT.

CONNECTING TO EXISTING FACILITIES:

1. UNLESS OTHERWISE SHOWN OR SPECIFIED, DETERMINE METHODS OF CONNECTING NEW WORK TO EXISTING FACILITIES, AND OBTAIN ENGINEER'S REVIEW AND ACCEPTANCE OF PROPOSED CONNECTIONS.
2. DETERMINE LOCATION, ELEVATION, NATURE, MATERIALS, DIMENSIONS, AND CONFIGURATIONS OF EXISTING FACILITIES WHERE NECESSARY FOR CONNECTING NEW WORK.
3. INSPECT EXISTING RECORD DRAWINGS AND SHOP DRAWINGS, CONDUCT EXPLORATORY EXCAVATIONS AND FIELD INSPECTIONS, AND CONDUCT SIMILAR ACTIVITIES AS NEEDED.
4. SHUTDOWN OF OWNER'S EXISTING FACILITIES PRIOR TO CONNECTION, IF NECESSARY, SHALL BE BY OWNER OR AS SPECIFIED.
5. PRIOR TO BEGINNING CONNECTION WORK, THE CONTRACTOR SHALL MEET ALL STATED, REGULATORY, AND STATUTORY NOTICE REQUIREMENTS.

RESTORATION NOTES:

1. CONTRACTOR SHALL SEED ALL GRASS AREAS DISTURBED BY THE CONSTRUCTION UNLESS OTHERWISE SPECIFIED. (SEE PLANS AND SPECIFICATION FOR DETAILS), AREA OF DISTURBANCE SHALL BE MINIMIZED TO REDUCE SEEDING.
2. RESTORATION OF THE SITE SHALL BE MADE WITH "IN KIND" MATERIALS.
3. DAMAGED COUNTY OR PRIVATE PROPERTY SHALL BE REPAIRED OR REPLACED TO MATCH PRECONSTRUCTION CONDITIONS.
4. CLEAN UP OF JOB SITE AT END OF EACH DAY.
5. MAINTAIN PROPER STORAGE OF HAZARDOUS MATERIALS, IF ANY, ONSITE.

PAVEMENT AND DRIVEWAY NOTES:

1. PAVEMENT STRIPING, IF PRESENT, SHALL BE REPLACED TO MATCH PRECONSTRUCTION CONDITIONS UNLESS OTHERWISE INDICATED ON THE PLANS.
2. ALL PAVEMENT REMOVED OR DAMAGED BY THIS CONSTRUCTION IN EXCESS OF THAT INDICATED ON THE PLANS SHALL BE REPLACED, "IN KIND" AT THE CONTRACTOR'S EXPENSE.
3. THE CONTRACTOR SHALL KEEP ALL PAVEMENTS CLEAN AND FREE OF MUD, ROCK, AND DEBRIS DURING CONSTRUCTION. COST SHALL BE CONSIDERED INCIDENTAL TO OTHER ITEMS.
4. CONTRACTOR SHALL NOTIFY PROPERTY OWNERS (PREFERABLY IN PERSON) 24 HOURS IN ADVANCE OF ANY DISRUPTED ACCESS TO THEIR DRIVEWAY.
5. CONTRACTOR SHALL NOT DISRUPT ACCESS TO A RESIDENT'S DRIVEWAY FOR MORE THAN ONE (1) DAY NOR FOR A TOTAL OF SIX (6) DAYS THROUGHOUT THE LIFE OF THE PROJECT. ONE DAY SHALL BE CONSIDERED A PERIOD OF TIME OF EIGHT (8) CONSECUTIVE HOURS TO 24 CONSECUTIVE HOURS.

LEGEND:

	EXISTING TREE	ADT	AVERAGE DAILY TRAFFIC
	BENCHMARK	BOP	BEGINNING OF PROJECT
	CRASHWORTHY END TERMINAL	BK	BOOK
	MAILBOX	BM	BENCHMARK
	POWER POLE	BRG	BEARING
	POWER POLE & GUY WIRE	CL	CENTERLINE
	ROAD SIGN (EXISTING)	CMP	CORRUGATED METAL PIPE
	ROAD SIGN (PROPOSED)	CP	CONTROL POINT
	STREET SIGN	D	DIAMETER
	TELEPHONE BOX	d	DEPTH
	PROPOSED CULVERT	DND	DO NOT DISTURB
	CONCRETE PCC	DWG	DRAWING
	EXISTING ASPHALTIC SURFACE	E	EASTING
	EXISTING BUILDING	EOP	END OF PROJECT
	CONCRETE RUBBLE & DEBRIS	EL, ELEV	ELEVATION
	ROCK EMBANKMENT, B36 "CREEK BANKS"	HGL	HYDRAULIC GRADE LINE
	ROCK BACKFILL, R18 "SCOUR HOLE" & "ROAD DITCHES"	HORIZ	HORIZONTAL
	CABLE LINE	INCR	INCREASING
	CENTER LINE	INT	INTERMEDIATE
	EXISTING CONTOUR	LHF	LEFT HAND FORWARD
	EXISTING FENCE LINE	LF	LINEAR FEET
	HYDRAULIC GRADE LINE	LPA	LOCAL PUBLIC AGENCY
	HYDRAULIC GRADE LINE	LT	LEFT
	MAINLINE	ML	MAINLINE
	NORTHING	N	NORTHING
	OUTSIDE DIAMETER	O.D.	OUTSIDE DIAMETER
	OFFSET	O/S	OFFSET
	POINT OF CURVE	PC	POINT OF CURVE
	PERMANENT DRAINAGE EASEMENT	PDE	PERMANENT DRAINAGE EASEMENT
	PAGE	PG	PAGE
	POINT OF INTERSECTION	PI	POINT OF INTERSECTION
	PROPERTY LINE	PL	PROPERTY LINE
	PERMANENT ROAD EASEMENT	PRE	PERMANENT ROAD EASEMENT
	POINT OF TANGENT	PT	POINT OF TANGENT
	FLOW (CFS)	Q	FLOW (CFS)
	REINFORCED CONCRETE PIPE	RCP	REINFORCED CONCRETE PIPE
	ROADWAY	RDWY	ROADWAY
	RIGHT HAND FORWARD	RHF	RIGHT HAND FORWARD
	RIGHT-OF-WAY	ROW, R/W	RIGHT-OF-WAY
	RIGHT	RT	RIGHT
	STATION	STA	STATION
	TO BE ABANDONED	TBA	TO BE ABANDONED
	TEMPORARY CONSTRUCTION EASEMENT	TCE	TEMPORARY CONSTRUCTION EASEMENT
	TO BE PROTECTED	TBP	TO BE PROTECTED
	TO BE REMOVED & RELOCATED	TBR&R	TO BE REMOVED & RELOCATED
	TYPICAL	TYP	TYPICAL
	USE IN PLACE	U/P	USE IN PLACE
	UTILITY POLE	U.P.	UTILITY POLE
	UNLESS NOTED OTHERWISE	UNO	UNLESS NOTED OTHERWISE
	VERTICAL	VERT	VERTICAL
	VERTICAL POINT OF CURVE	VPC	VERTICAL POINT OF CURVE
	VERTICAL POINT OF INTERSECTION	VPI	VERTICAL POINT OF INTERSECTION
	VERTICAL POINT OF TANGENT	VPT	VERTICAL POINT OF TANGENT

THE UNDERGROUND UTILITIES SHOWN HEREIN WERE PLOTTED FROM AVAILABLE INFORMATION AND DO NOT NECESSARILY REFLECT THE ACTUAL EXISTENCE, NONEXISTENCE, SIZE, TYPE, NUMBER, OR LOCATION OF THESE OR OTHER UTILITIES. THE GENERAL CONTRACTOR SHALL BE RESPONSIBLE FOR VERIFYING THE ACTUAL LOCATION OF ALL UNDERGROUND UTILITIES, SHOWN OR NOT SHOWN, AND SHALL LOCATE THE UTILITIES IN THE FIELD PRIOR TO ANY GRADING, EXCAVATION, OR CONSTRUCTION IMPROVEMENTS.

0	01/22/19	ISSUED FOR CONSTRUCTION	TRN
REV.	DATE	DESCRIPTION	APPROVED

QUANTITY SUMMARY TABLES:

ITEM DESCRIPTION	ESTIMATED QUANTITY	FINAL QUANTITY
ROADWAY	UNIT	UNIT
2013000 Clearing and Grubbing	0.5	AC
2022010 Removal of Improvements	1	LS
2022019 Sawcutting	47	LF
2035000 Unclassified Excavation	454	CY
2035500 Embankment in Place	110	CY
2036000 Compacting Embankment	110	CY
3040504 Type 5 Aggregate for Base (4" Thick) (Roadway)	191	SY
3040514 Type 5 Aggregate for Base (14" Thick) (Shoulders)	44	SY
4011209 Bituminous Pavement Mixture PG64-22, (BP-1) (Roadway & Shoulders)	30.6	TON
4013000 Bituminous Pavement Mixture PG64-22, (Base) (Roadway & Shoulders)	123.6	TON
4071005 Tack Coat	10	Gal
6061060 MGS Guardrail	75	LF
6063015 Crashworthy End Terminal (50' System Length)	2	EA
6066610 End Anchor (End Shoe Guardrail) (12.5' System Length)	2	EA
JSP Furnishing Rock Backfill, R18	153	CY
JSP Placing Rock Backfill, R18	153	CY
JSP Furnishing Rock Boulders, B36 (30"-42")	703	CY
JSP Placing Rock Boulders, B36 (30"-42")	703	CY
JSP 12" Flexible Storm Pipe & Banding	20	LF
6161097 Traffic Control (All Inclusive)	1	LS
6181000 Mobilization	1	LS
6274000 Contractor Furnished Surveying and Staking (MoDOT Spec.)	1	LS
8051000A Seeding & Mulching	0.2	AC
8061019 Silt Fence	371	LF
8065599 SWPPP Design, Installation, Maintenance, & Removal	1	LS
8080099 Restoration	1	LS


* SEE B-101 FOR BRIDGE QUANTITIES

QUANTITY SUMMARY (2B)




ITEM NO.	BID ITEM	DESCRIPTION	SHEET	STATION	LOCATION	QUANTITY	UNIT
ROADWAY							
1	2013000	Clearing and Grubbing	C-101	Project	LT & RT	0.5	AC
TOTAL						0.5	AC
2	2022010	Removal of Improvements	C-101	Project	-	1	LS
TOTAL						1	LS
3	2022019	Sawcutting	C-101	Sta 2+50	LT & RT	24	LF
3	2022019	Sawcutting	C-101	Sta 3+40	LT & RT	23	LF
TOTAL						47	LF
4	2035000	Unclassified Excavation	C-101	Project	LT & RT	454	CY
TOTAL						454	CY
5	2035500	Embankment in Place	C-101	Project	LT & RT	110	CY
TOTAL						110	CY
6	2036000	Compacting Embankment	C-101	Project	LT & RT	110	CY
TOTAL						110	CY
7	3040504	Type 5 Aggregate for Base (4" Thick) (Roadway)	C-101	Sta 2+50 - 2+79	LT & RT	84	SY
7	3040504	Type 5 Aggregate for Base (4" Thick) (Roadway)	C-101	Sta 3+03 - 3+40	LT & RT	107	SY
TOTAL						191	SY
8	3040514	Type 5 Aggregate for Base (14" Thick) (Shoulders)	C-101	Sta 2+50 - 2+79	LT & RT	19	SY
8	3040514	Type 5 Aggregate for Base (14" Thick) (Shoulders)	C-101	Sta 3+03 - 3+40	LT & RT	25	SY
TOTAL						44	SY
9	4011209	Bituminous Pavement Mixture PG64-22, (BP-1) (Roadway & Shoulders)	C-101	Sta 2+50 - 3+40	LT & RT	30.6	TON
TOTAL						30.6	TON
10	4013000	Bituminous Pavement Mixture PG64-22, (Base) (Roadway & Shoulders)	C-101	Sta 2+50 - 3+40	LT & RT	123.6	TON
TOTAL						123.6	TON
11	4071005	Tack Coat	C-101	Sta 2+79 - 3+03	LT & RT	10	Gal
TOTAL						10	Gal
12	6061060	MGS Guardrail	C-101	@ Bridge	NE	0.0	LF
12	6061060	MGS Guardrail	C-101	@ Bridge	NW	37.5	LF
12	6061060	MGS Guardrail	C-101	@ Bridge	SE	0.0	LF
12	6061060	MGS Guardrail	C-101	@ Bridge	SW	37.5	LF
TOTAL						75	LF
13	6063015	Crashworthy End Terminal (50' System Length)	C-101	Sta 2+25	LT	1	EA
13	6063015	Crashworthy End Terminal (50' System Length)	C-101	Sta 3+53	LT	1	EA
TOTAL						2	EA
14	6066610	End Anchor (End Shoe Guardrail) (12.5' System Length)	C-101	Sta 2+59	RT	1	EA
14	6066610	End Anchor (End Shoe Guardrail) (12.5' System Length)	C-101	Sta 3+47	RT	1	EA
TOTAL						2	EA

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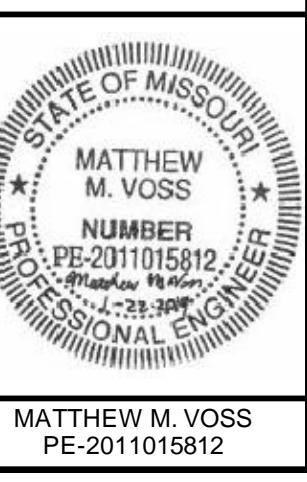
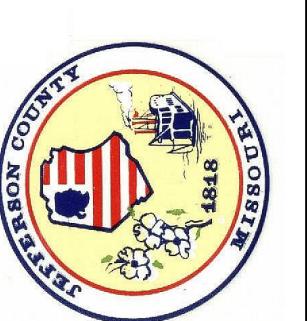
0	01/22/19	ISSUED FOR CONSTRUCTION

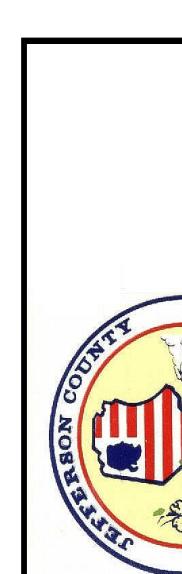

Mvoss
January 22, 2019

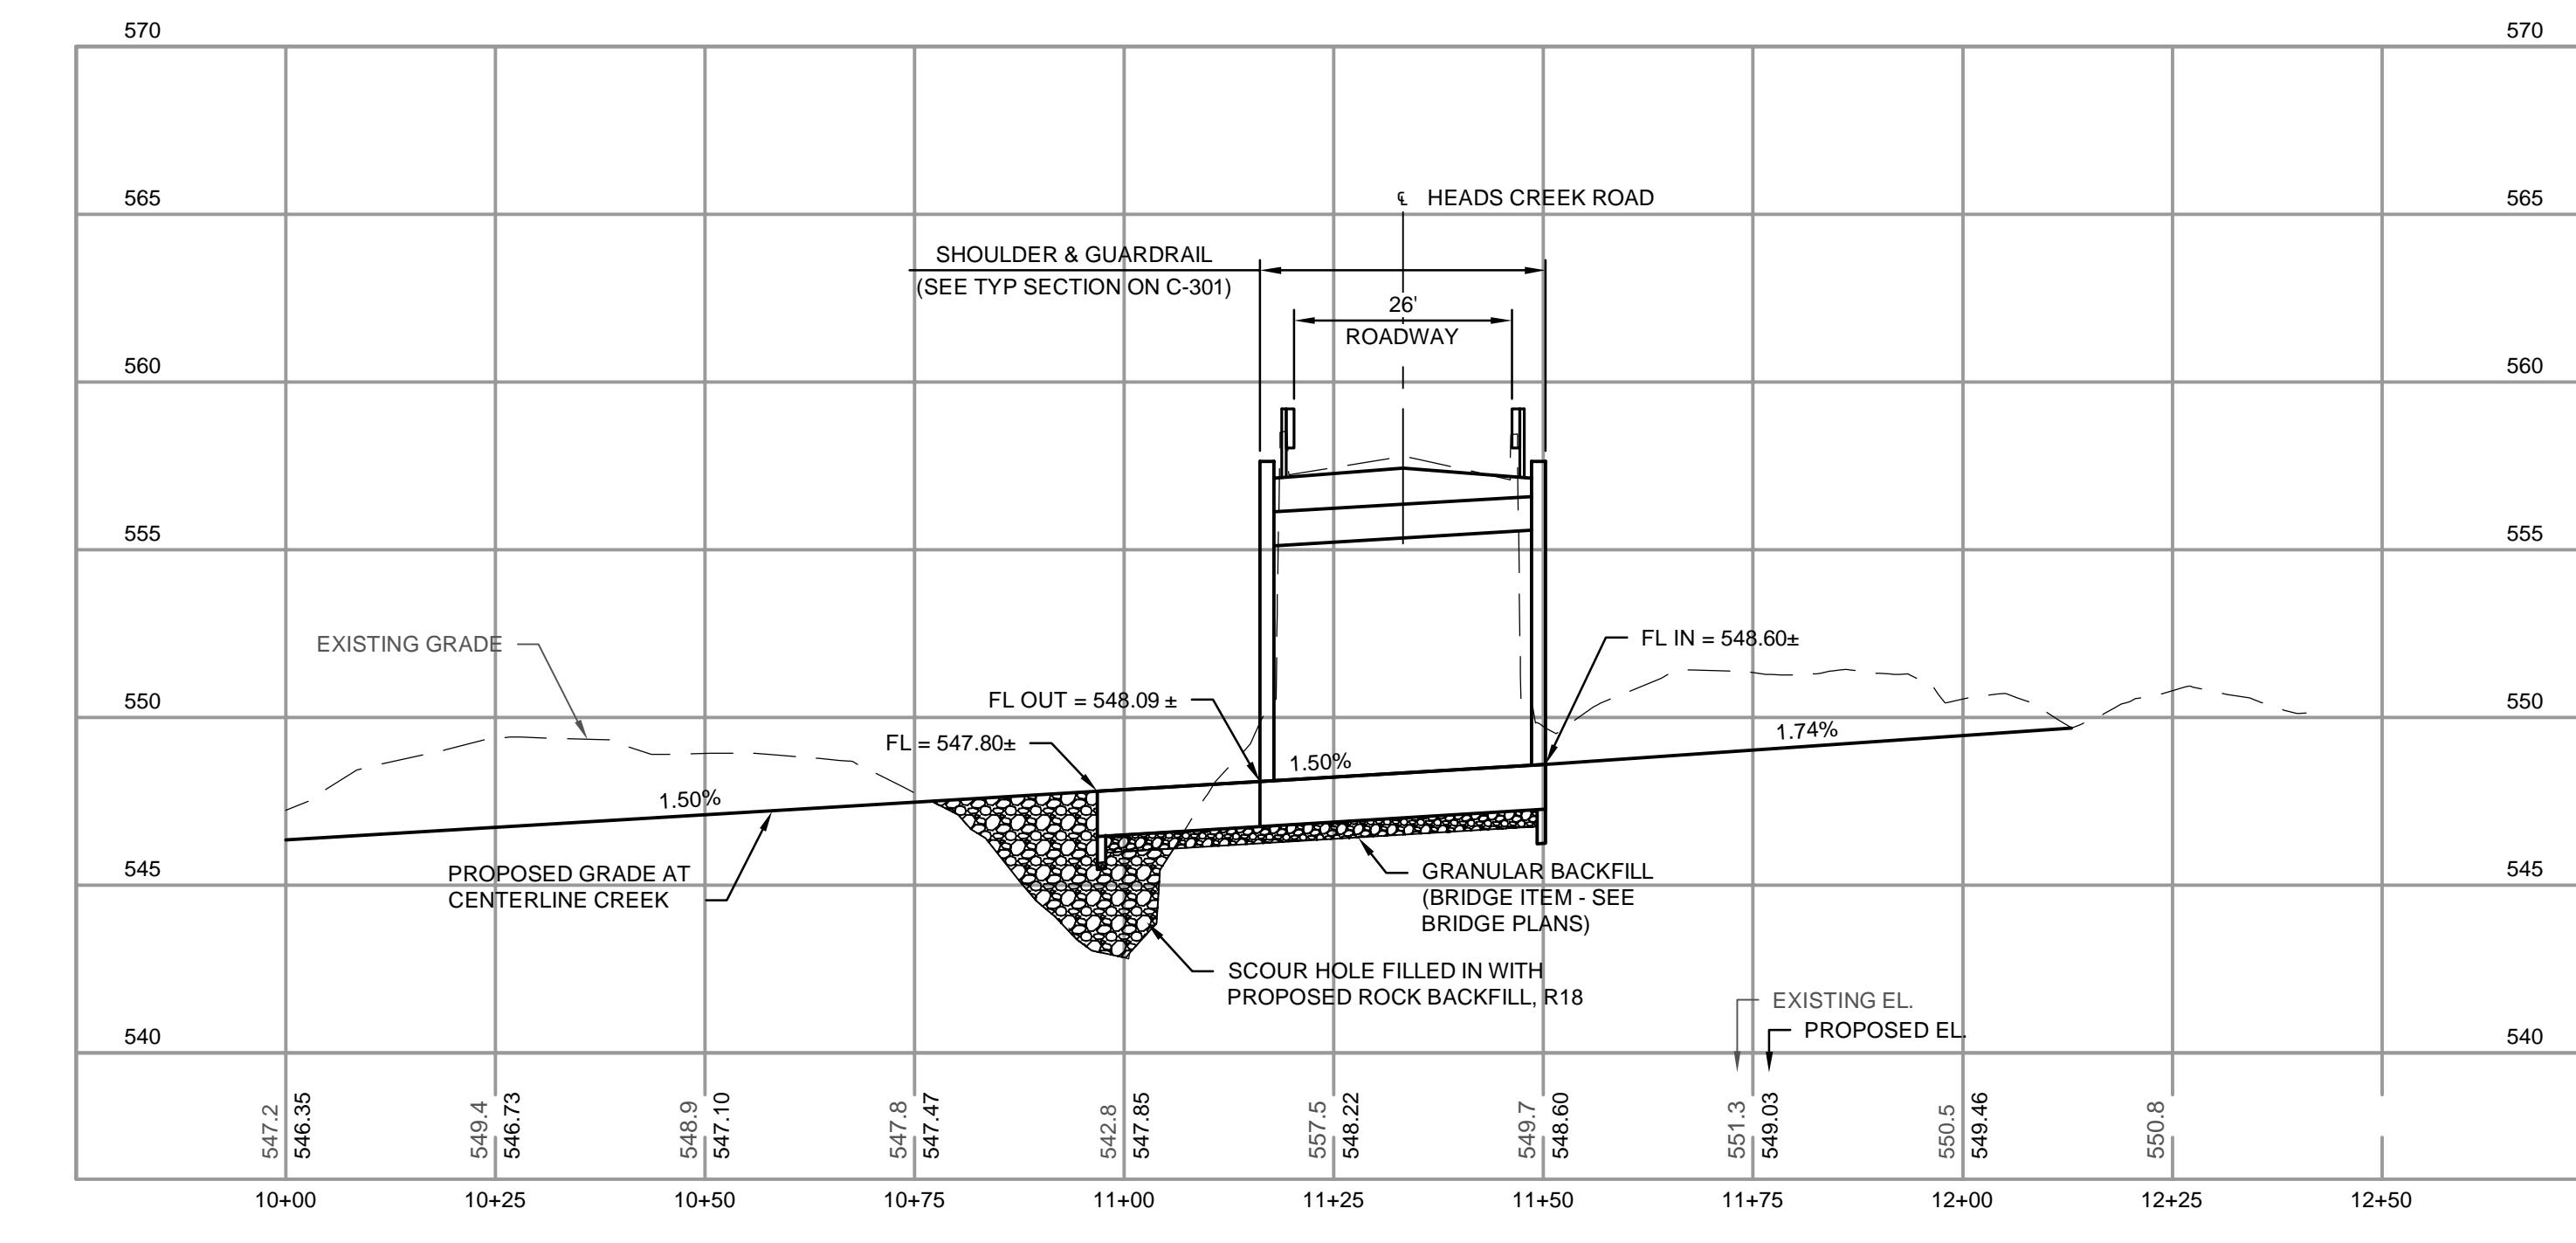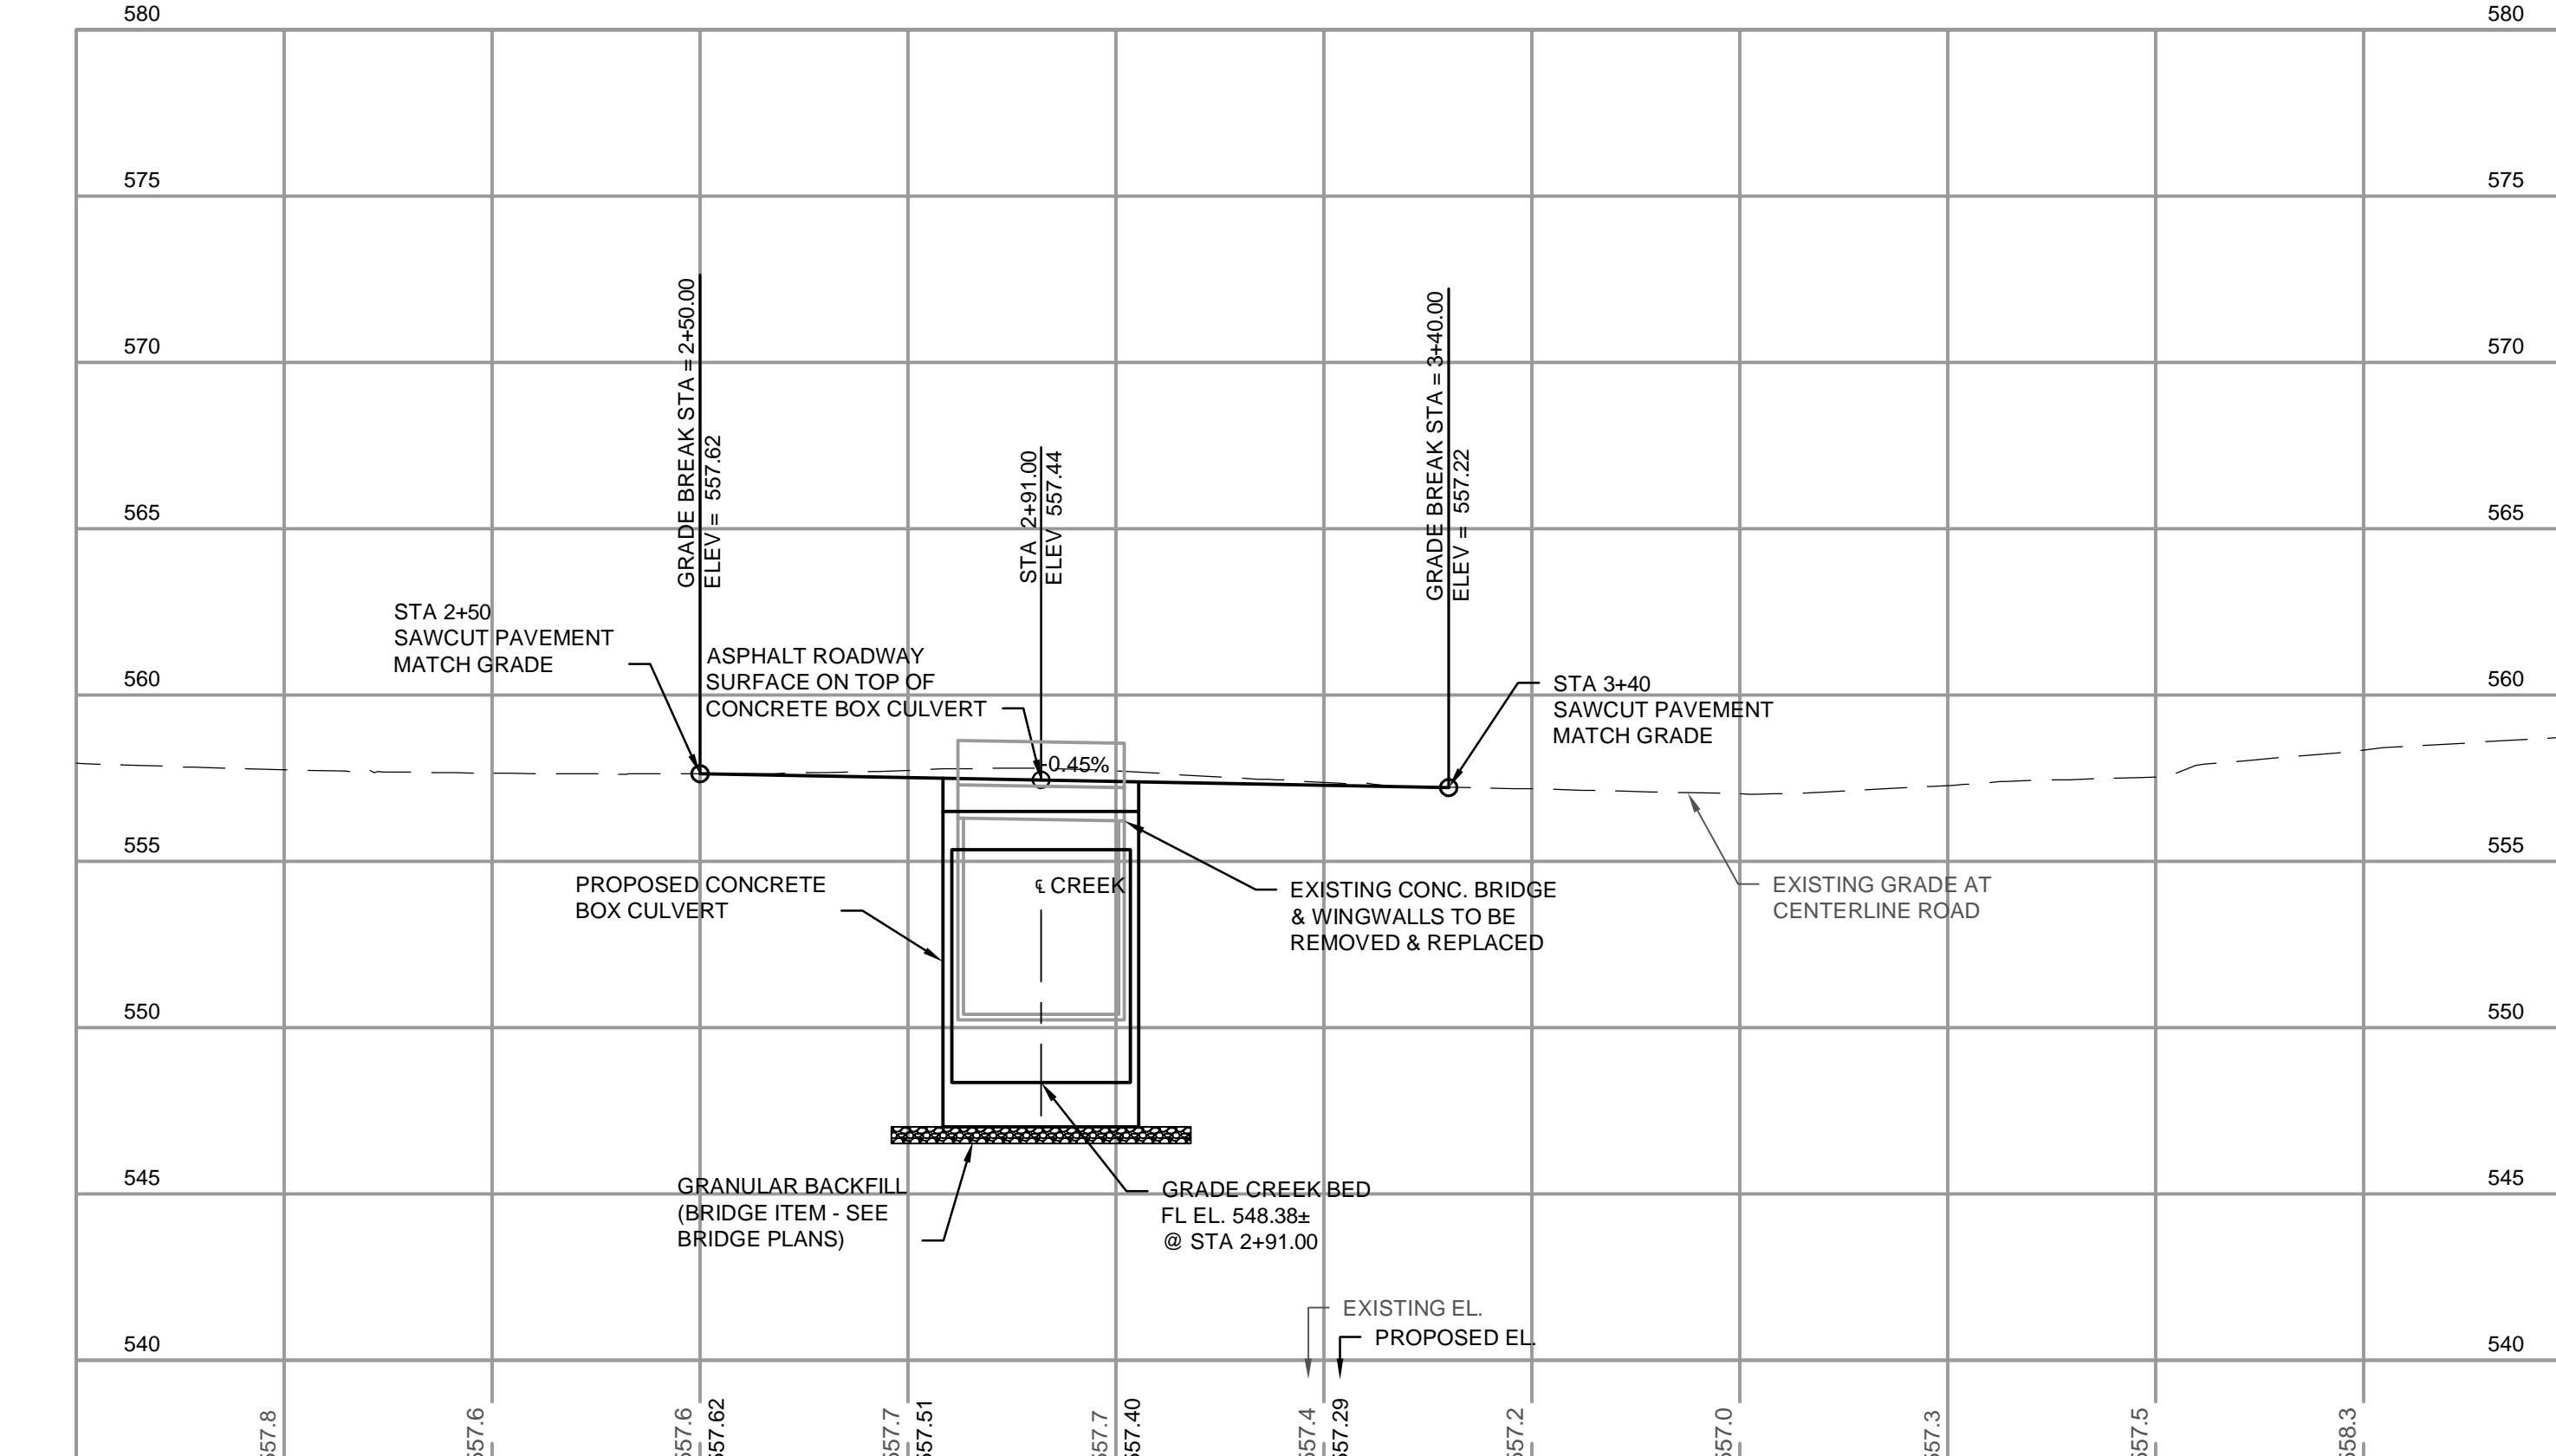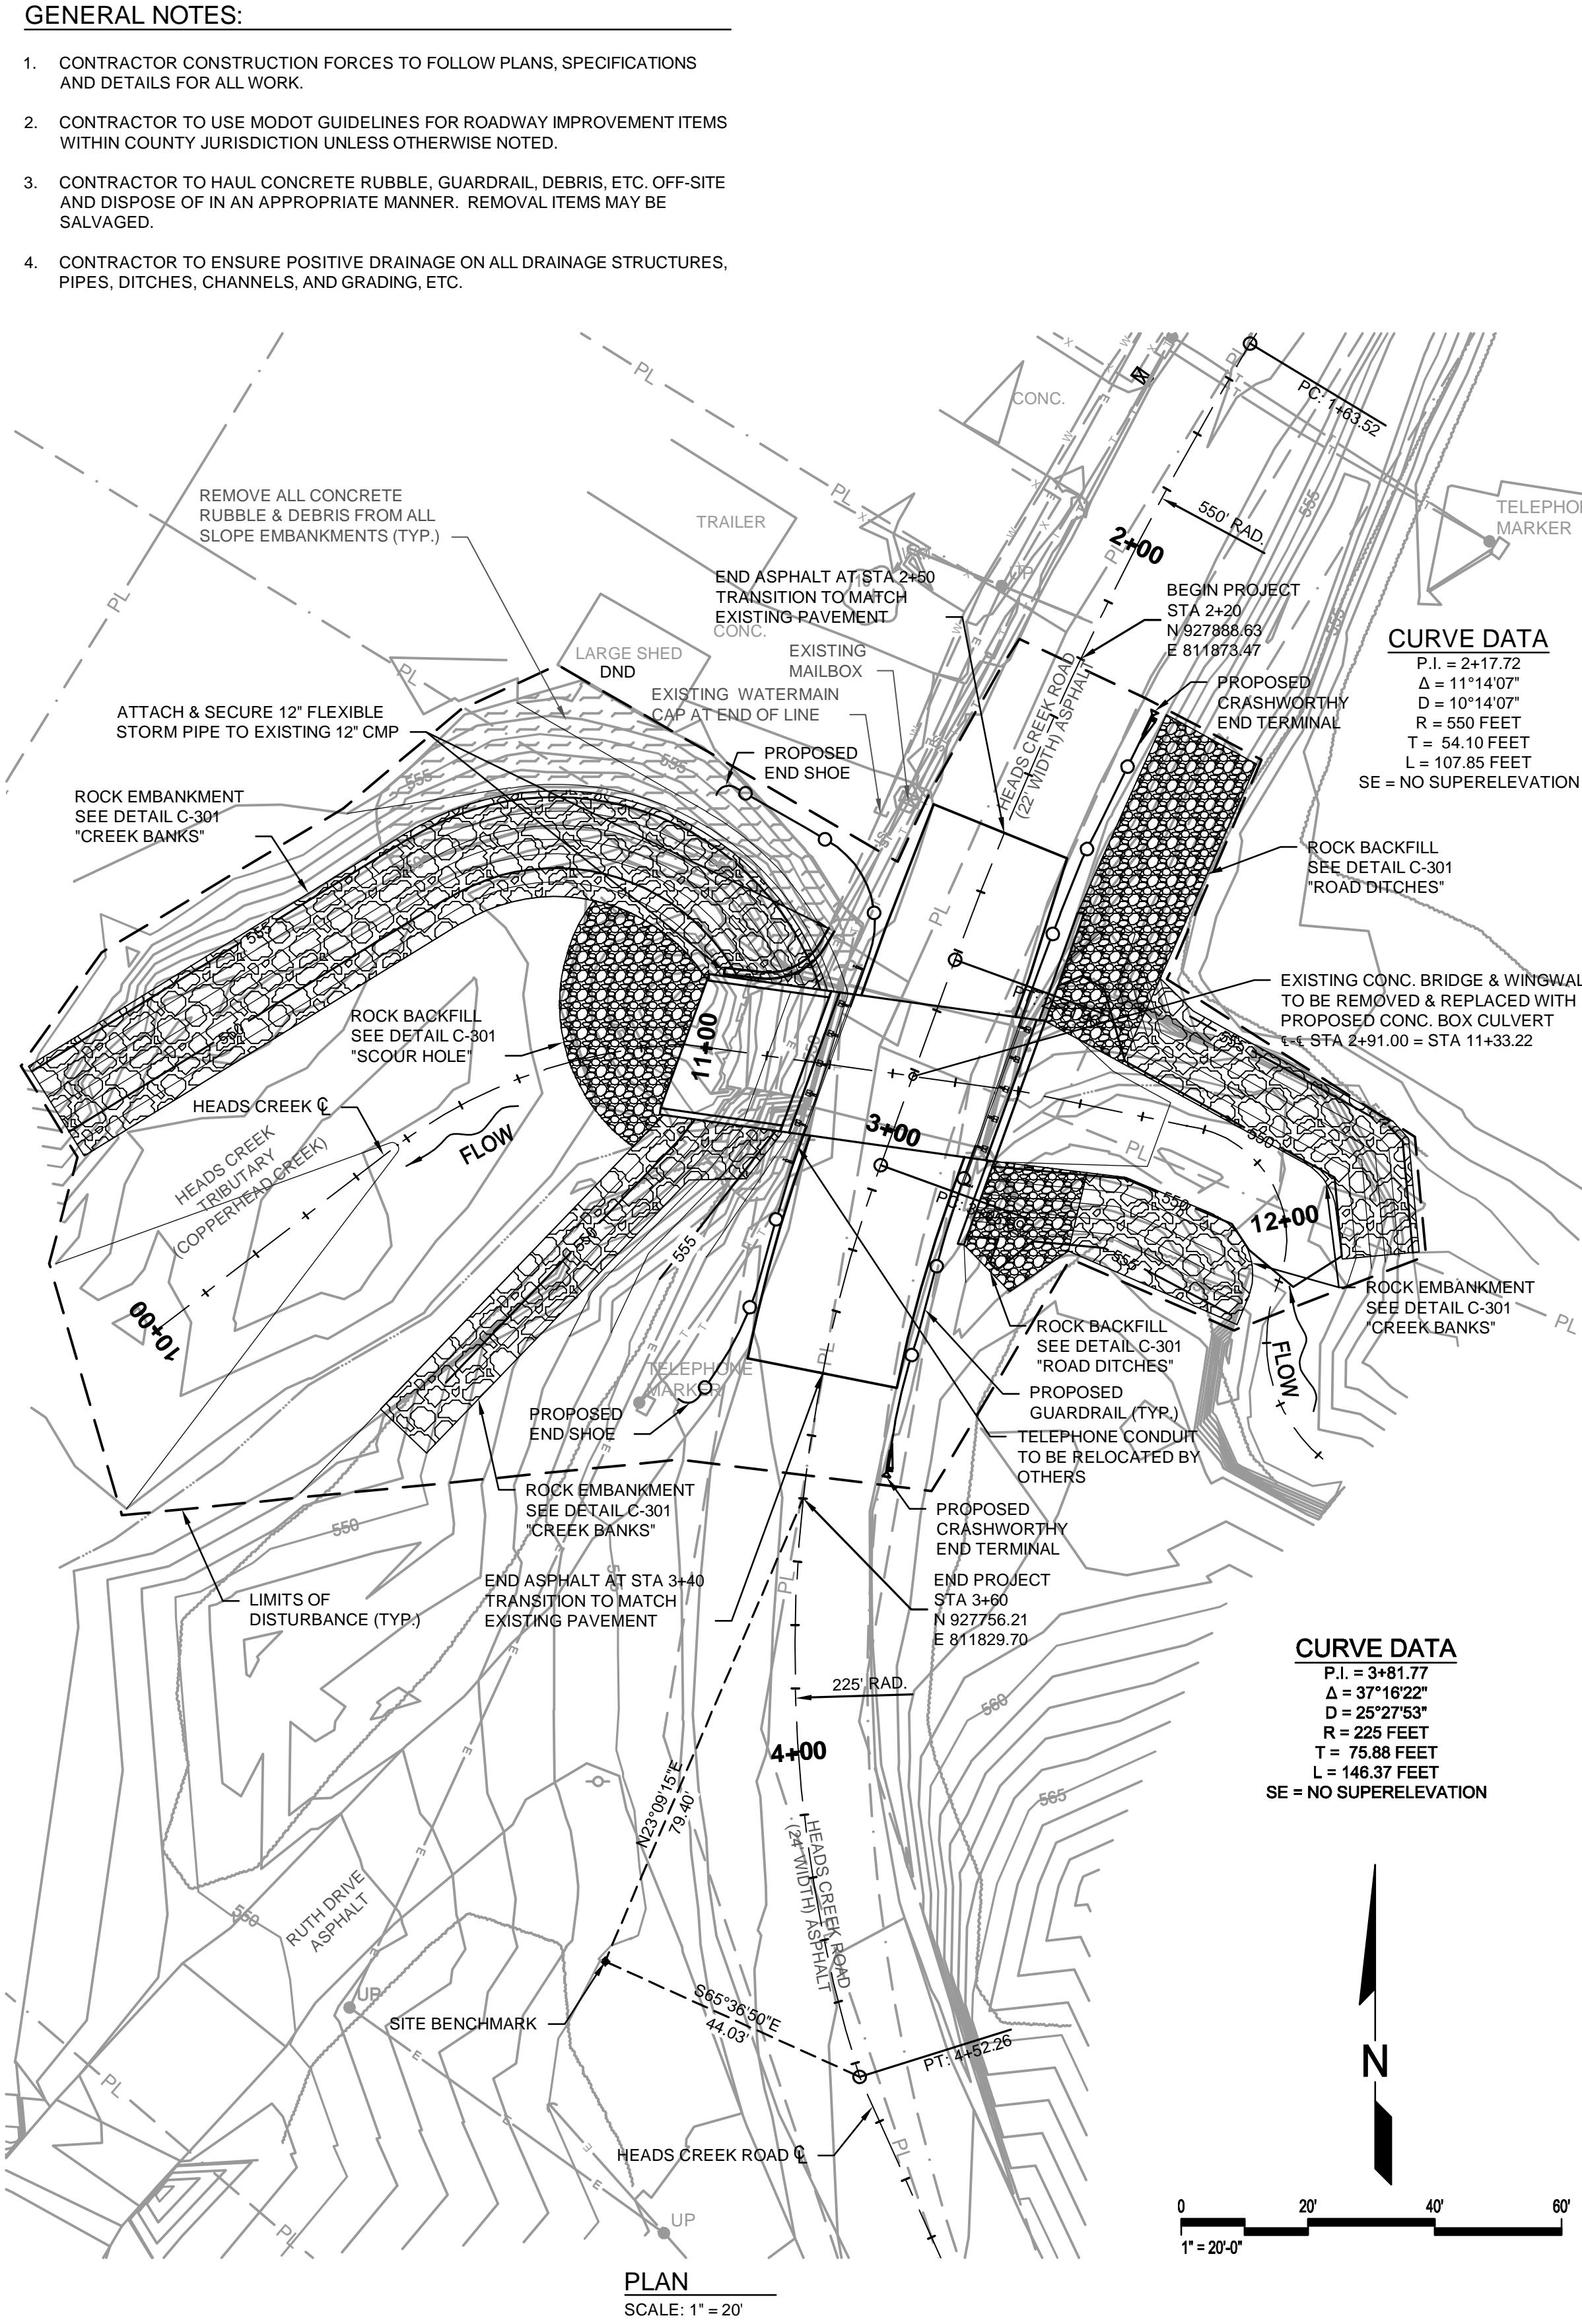


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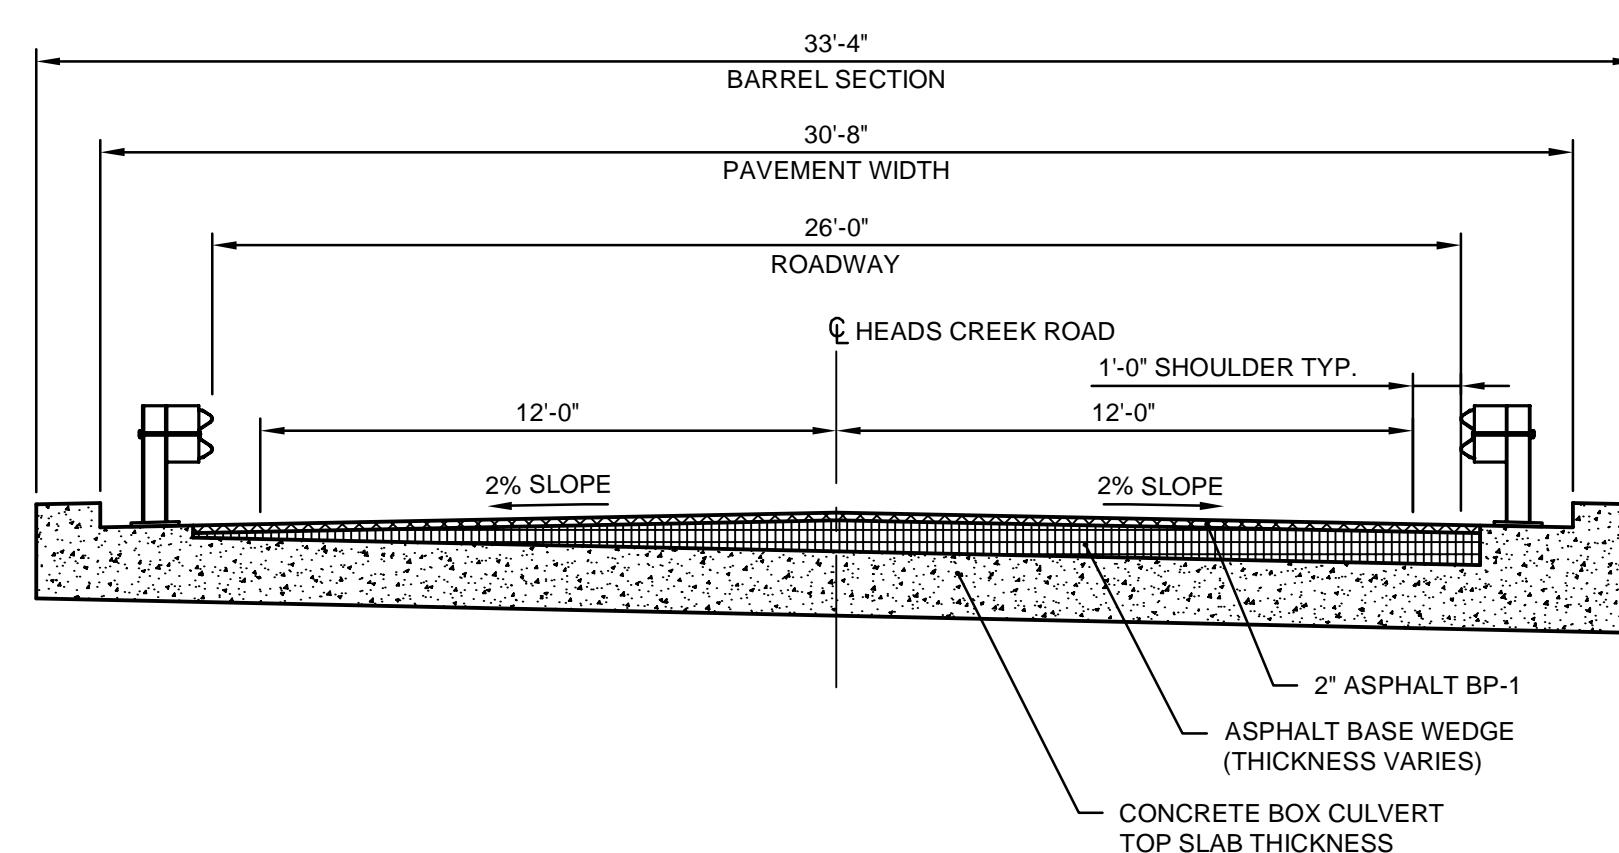
Mvoss
January 22, 2019

CULVERT PLAN & PROFILES
COUNTY PROJECT NO. PW19135BXC
HEADS CREEK ROAD BRIDGE
JEFFERSON COUNTY, MISSOURI



TYPICAL SECTION - ROADWAY
SCALE: 1"= 4'-0"

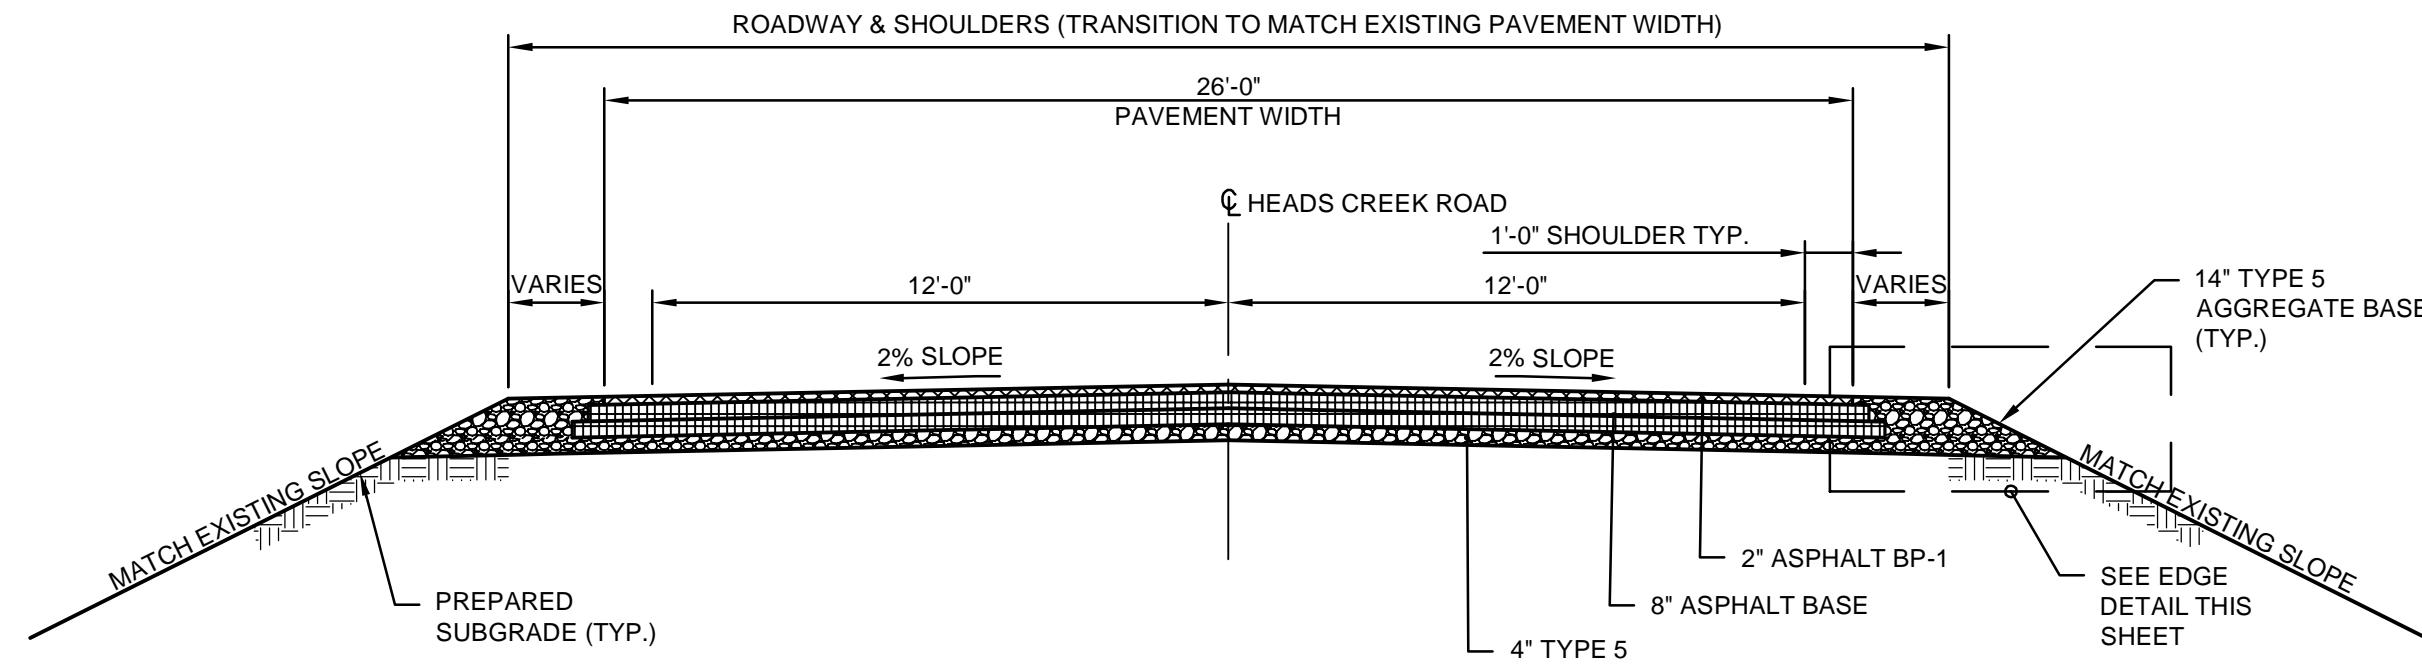
STA 2+50 THRU 2+79
STA 3+03 THRU 3+40



TYPICAL SECTION - ON STRUCTURE
SCALE: 1"= 4'-0"


STA 2+79 THRU 3+03

(PERPENDICULAR TO ROADWAY CENTERLINE)
(VIEW LOOKING SOUTH AT CENTERLINE STRUCTURE)
* SEE BRIDGE PLANS FOR CULVERT DETAILS

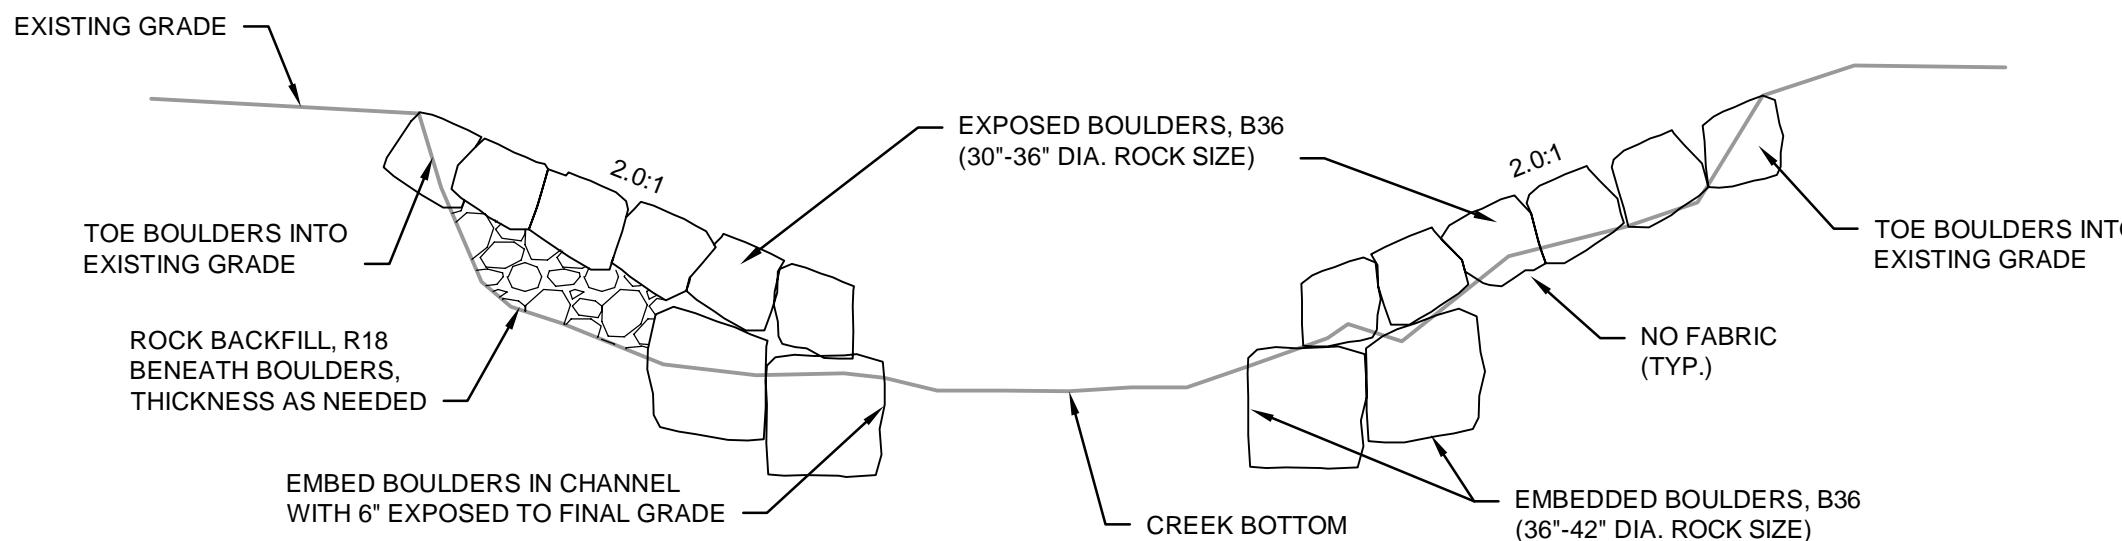


TYPICAL SECTION - CREEK BANKS
NOT TO SCALE


* BOULDERS WILL BE PAID UNDER BID ITEMS
* FURNISHING & PLACING ROCK BOULDERS 30"-42"

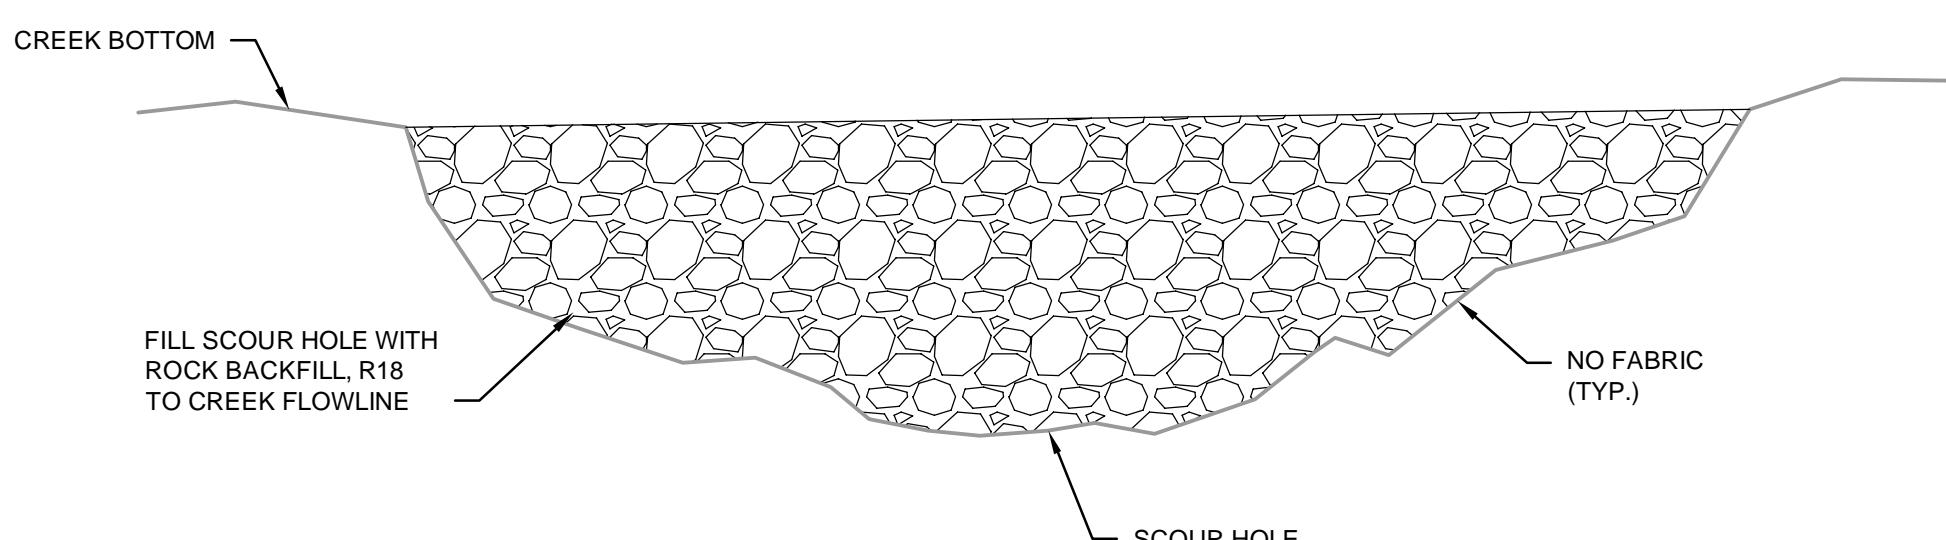

TYPICAL SECTION - SCOUR HOLE
NOT TO SCALE

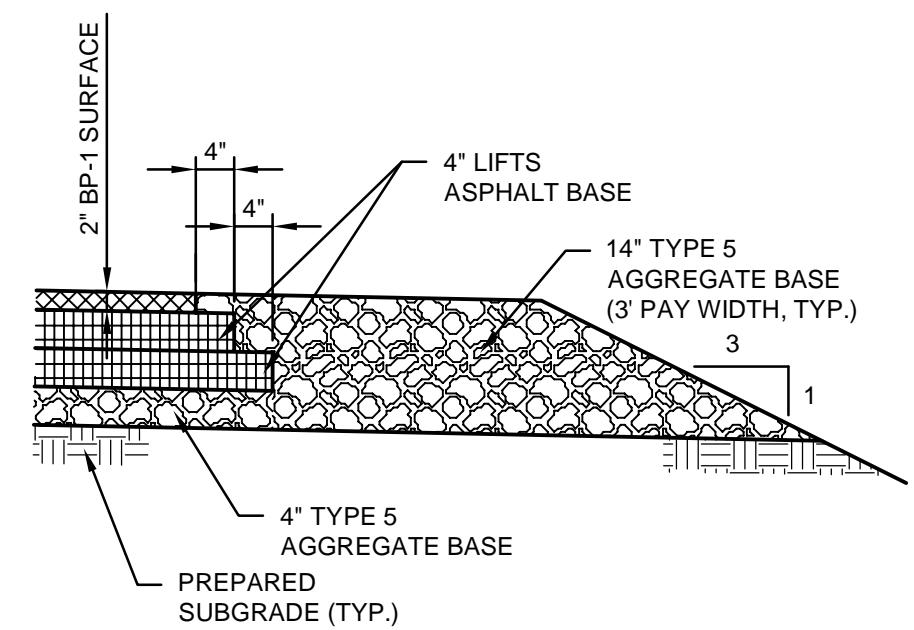


TYPICAL PAVEMENT - EDGE DETAIL
NOT TO SCALE

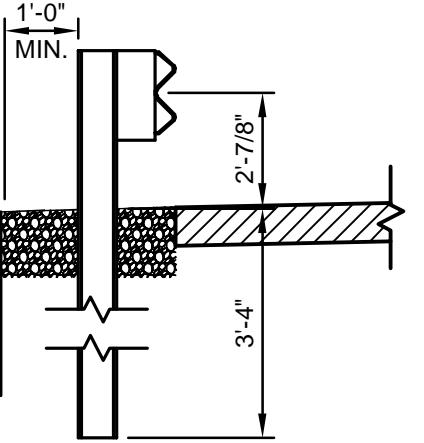

TYPICAL DETAIL - MGS GUARDRAIL
NOT TO SCALE


GUARD RAIL NOTES:
1. INSTALL GUARDRAIL PER SPECIFICATIONS.
2. INSTALL POST PER SPECIFICATIONS.

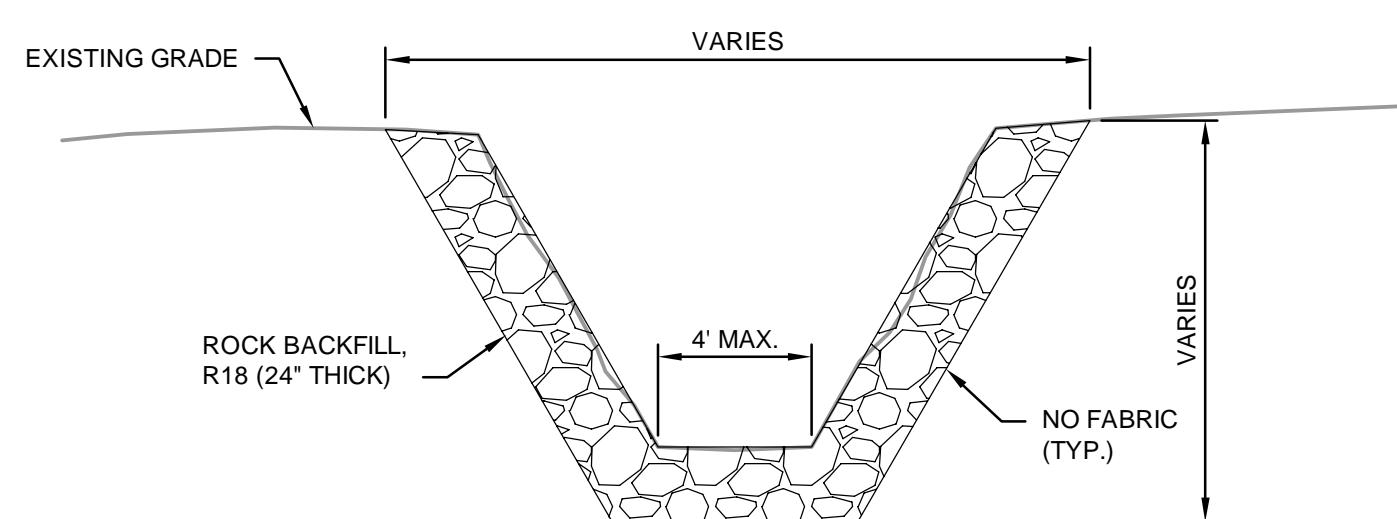


TYPICAL SECTION - ROAD DITCHES
NOT TO SCALE

NOTE:

* IF LARGE BOULDERS ARE NOT READILY AVAILABLE, CONTRACTOR MAY SUBSTITUTE ARMAMENT OF CREEK BANKS WITH AN ALTERNATE NATURAL MATERIAL (NON-RUBBLE), WHICH CAN WITHSTAND EROSIONAL SCOURING POTENTIAL AND FLOW VELOCITIES UP TO 15 FT/S. CONTRACTOR MUST GAIN COUNTY APPROVAL PRIOR TO CONSTRUCTION OF SAID MATERIAL.

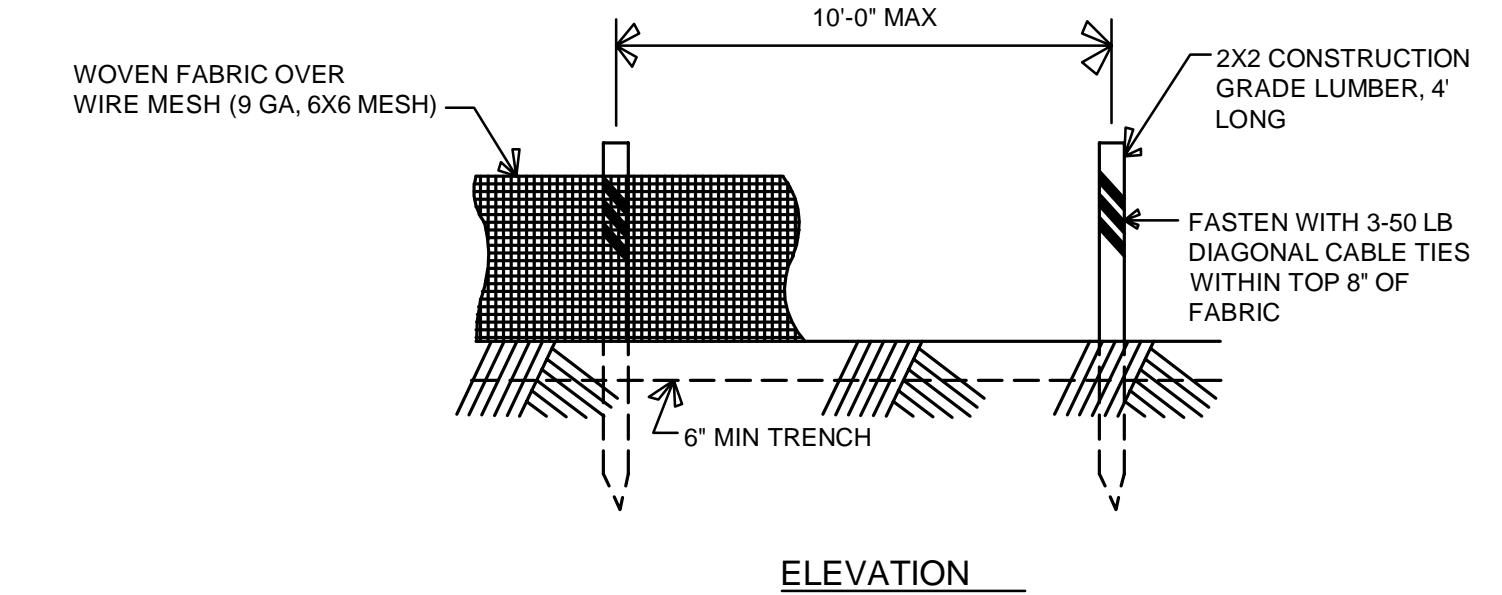

ELEVATION

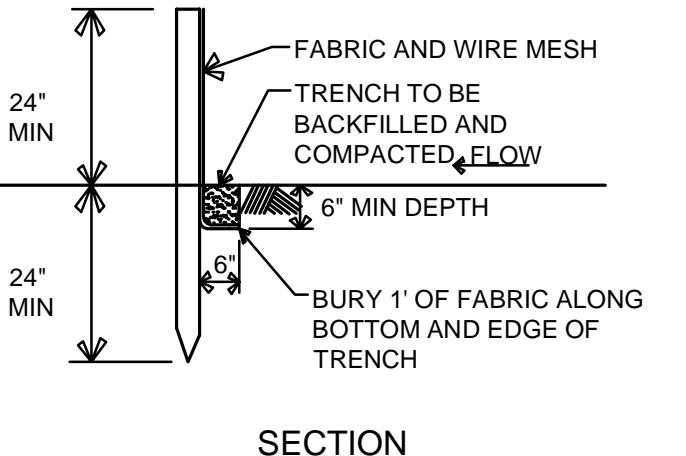

SECTION
NOT TO SCALE


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REV.	DATE	DESCRIPTION	APPROVED
0	01/22/19	ISSUED FOR CONSTRUCTION	TRN


CDG PROJECT NO.
18013
DRAWING NO.
C-301

TYPICAL DETAILS
COUNTY PROJECT NO. PW19135BXC
HEADS CREEK ROAD BRIDGE
JEFFERSON COUNTY, MISSOURI

CDG ENGINEERS
One Campbell Plaza
St. Louis, Missouri 63139
T. 314.781.7770
F. 314.781.8075
Missouri State Certificate of Authority # 1271

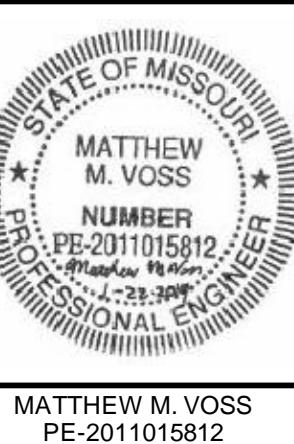

Mvoss
January 22, 2019

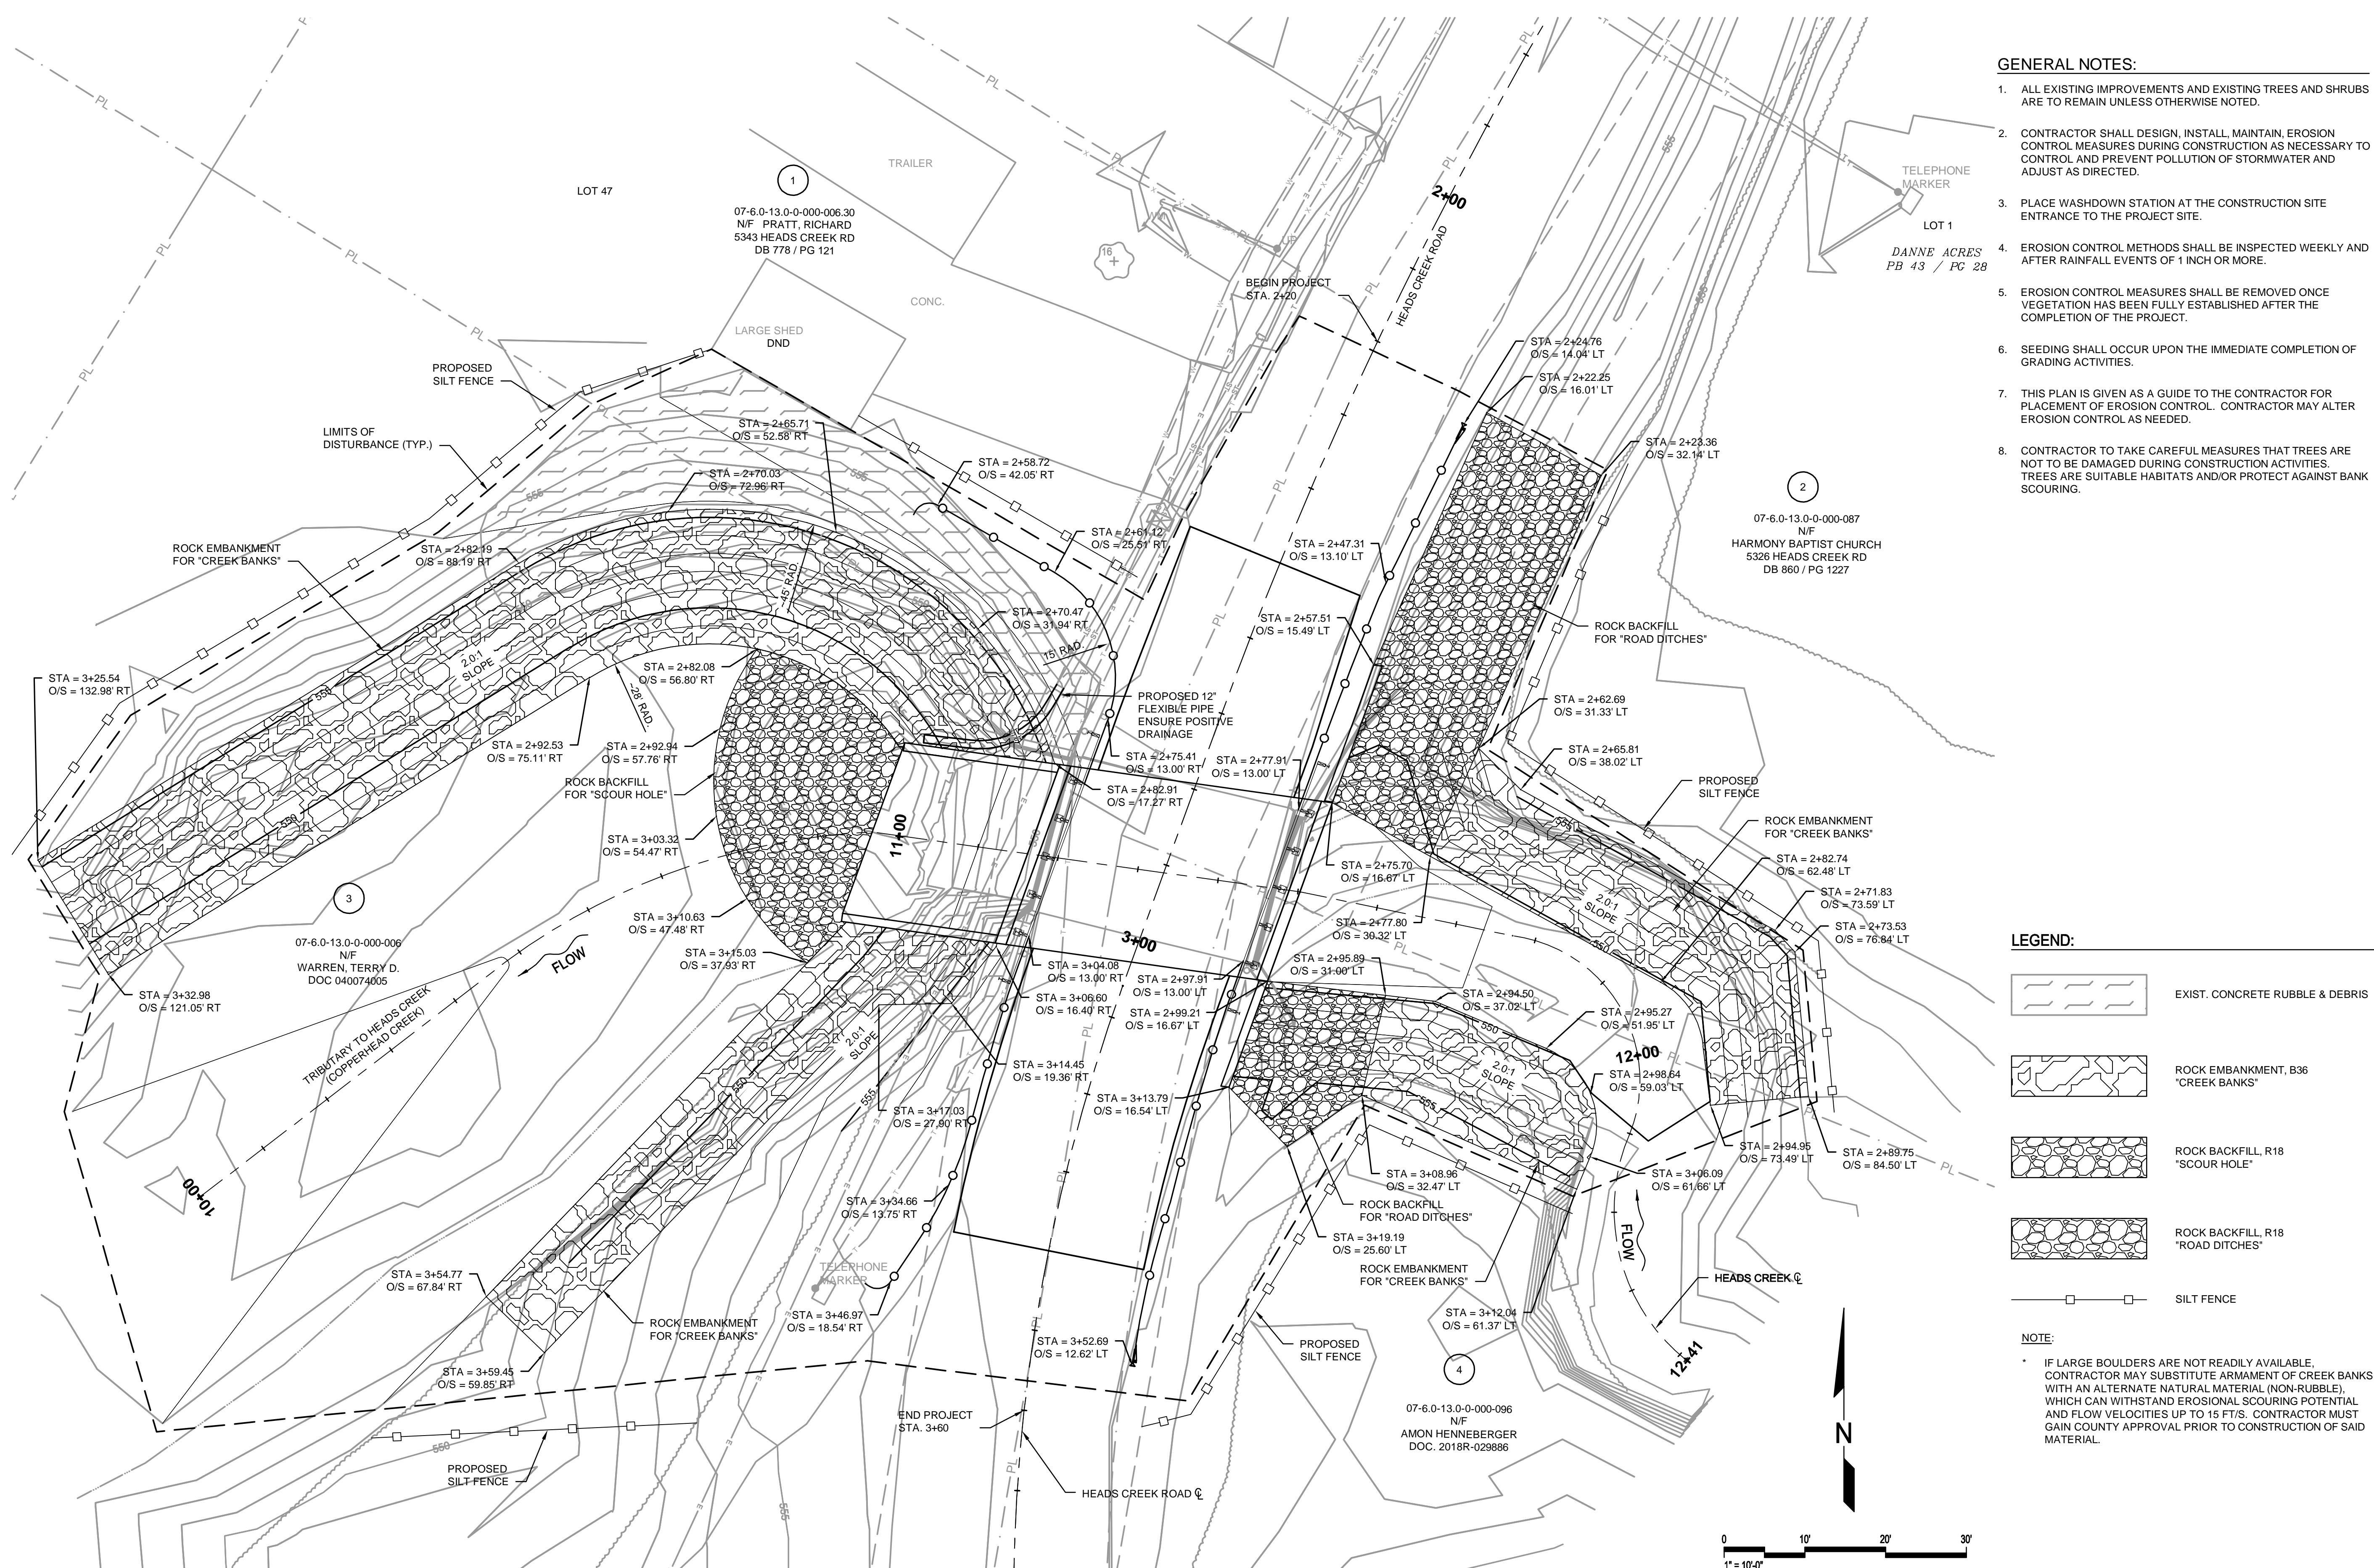

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GENERAL NOTES:


1. ALL EXISTING IMPROVEMENTS AND EXISTING TREES AND SHRUBS ARE TO REMAIN UNLESS OTHERWISE NOTED.
2. CONTRACTOR SHALL DESIGN, INSTALL, MAINTAIN, EROSION CONTROL MEASURES DURING CONSTRUCTION AS NECESSARY TO CONTROL AND PREVENT POLLUTION OF STORMWATER AND ADJUST AS DIRECTED.
3. PLACE WASHDOWN STATION AT THE CONSTRUCTION SITE ENTRANCE TO THE PROJECT SITE.
4. EROSION CONTROL METHODS SHALL BE INSPECTED WEEKLY AND AFTER RAINFALL EVENTS OF 1 INCH OR MORE.
5. EROSION CONTROL MEASURES SHALL BE REMOVED ONCE VEGETATION HAS BEEN FULLY ESTABLISHED AFTER THE COMPLETION OF THE PROJECT.
6. SEEDING SHALL OCCUR UPON THE IMMEDIATE COMPLETION OF GRADING ACTIVITIES.
7. THIS PLAN IS GIVEN AS A GUIDE TO THE CONTRACTOR FOR PLACEMENT OF EROSION CONTROL. CONTRACTOR MAY ALTER EROSION CONTROL AS NEEDED.
8. CONTRACTOR TO TAKE CAREFUL MEASURES THAT TREES ARE NOT TO BE DAMAGED DURING CONSTRUCTION ACTIVITIES. TREES ARE SUITABLE HABITATS AND/OR PROTECT AGAINST BANK SCOURING.

Mvoss
January 22, 2019

SITE GRADING PLAN
COUNTY PROJECT NO. PW19135BXC
HEADS CREEK ROAD BRIDGE
JEFFERSON COUNTY, MISSOURI

CDG PROJECT NO.
18013
DRAWING NO.
C-401

CDG ENGINEERS
T. 344-781-7770
F. 344-781-7075
One Campbell Plaza
St. Louis, Missouri 63139
Missouri State Certificate of Authority # 1271

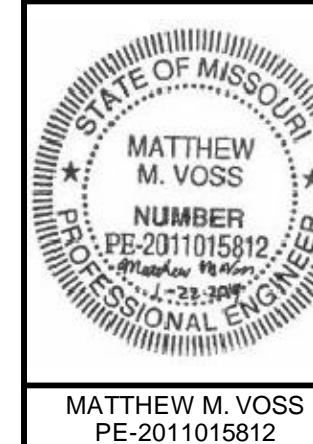


LEGEND:

- EXIST. CONCRETE RUBBLE & DEBRIS
- ROCK EMBANKMENT, B36 "CREEK BANKS"
- ROCK BACKFILL, R18 "SCOUR HOLE"
- ROCK BACKFILL, R18 "ROAD DITCHES"
- SILT FENCE

NOTE:

- IF LARGE BOULDERS ARE NOT READILY AVAILABLE, CONTRACTOR MAY SUBSTITUTE ARMAMENT OF CREEK BANKS WITH AN ALTERNATE NATURAL MATERIAL (NON-RUBBLE), WHICH CAN WITHSTAND EROSIONAL SCOURING POTENTIAL AND FLOW VELOCITIES UP TO 15 FT/S. CONTRACTOR MUST GAIN COUNTY APPROVAL PRIOR TO CONSTRUCTION OF SAID MATERIAL.

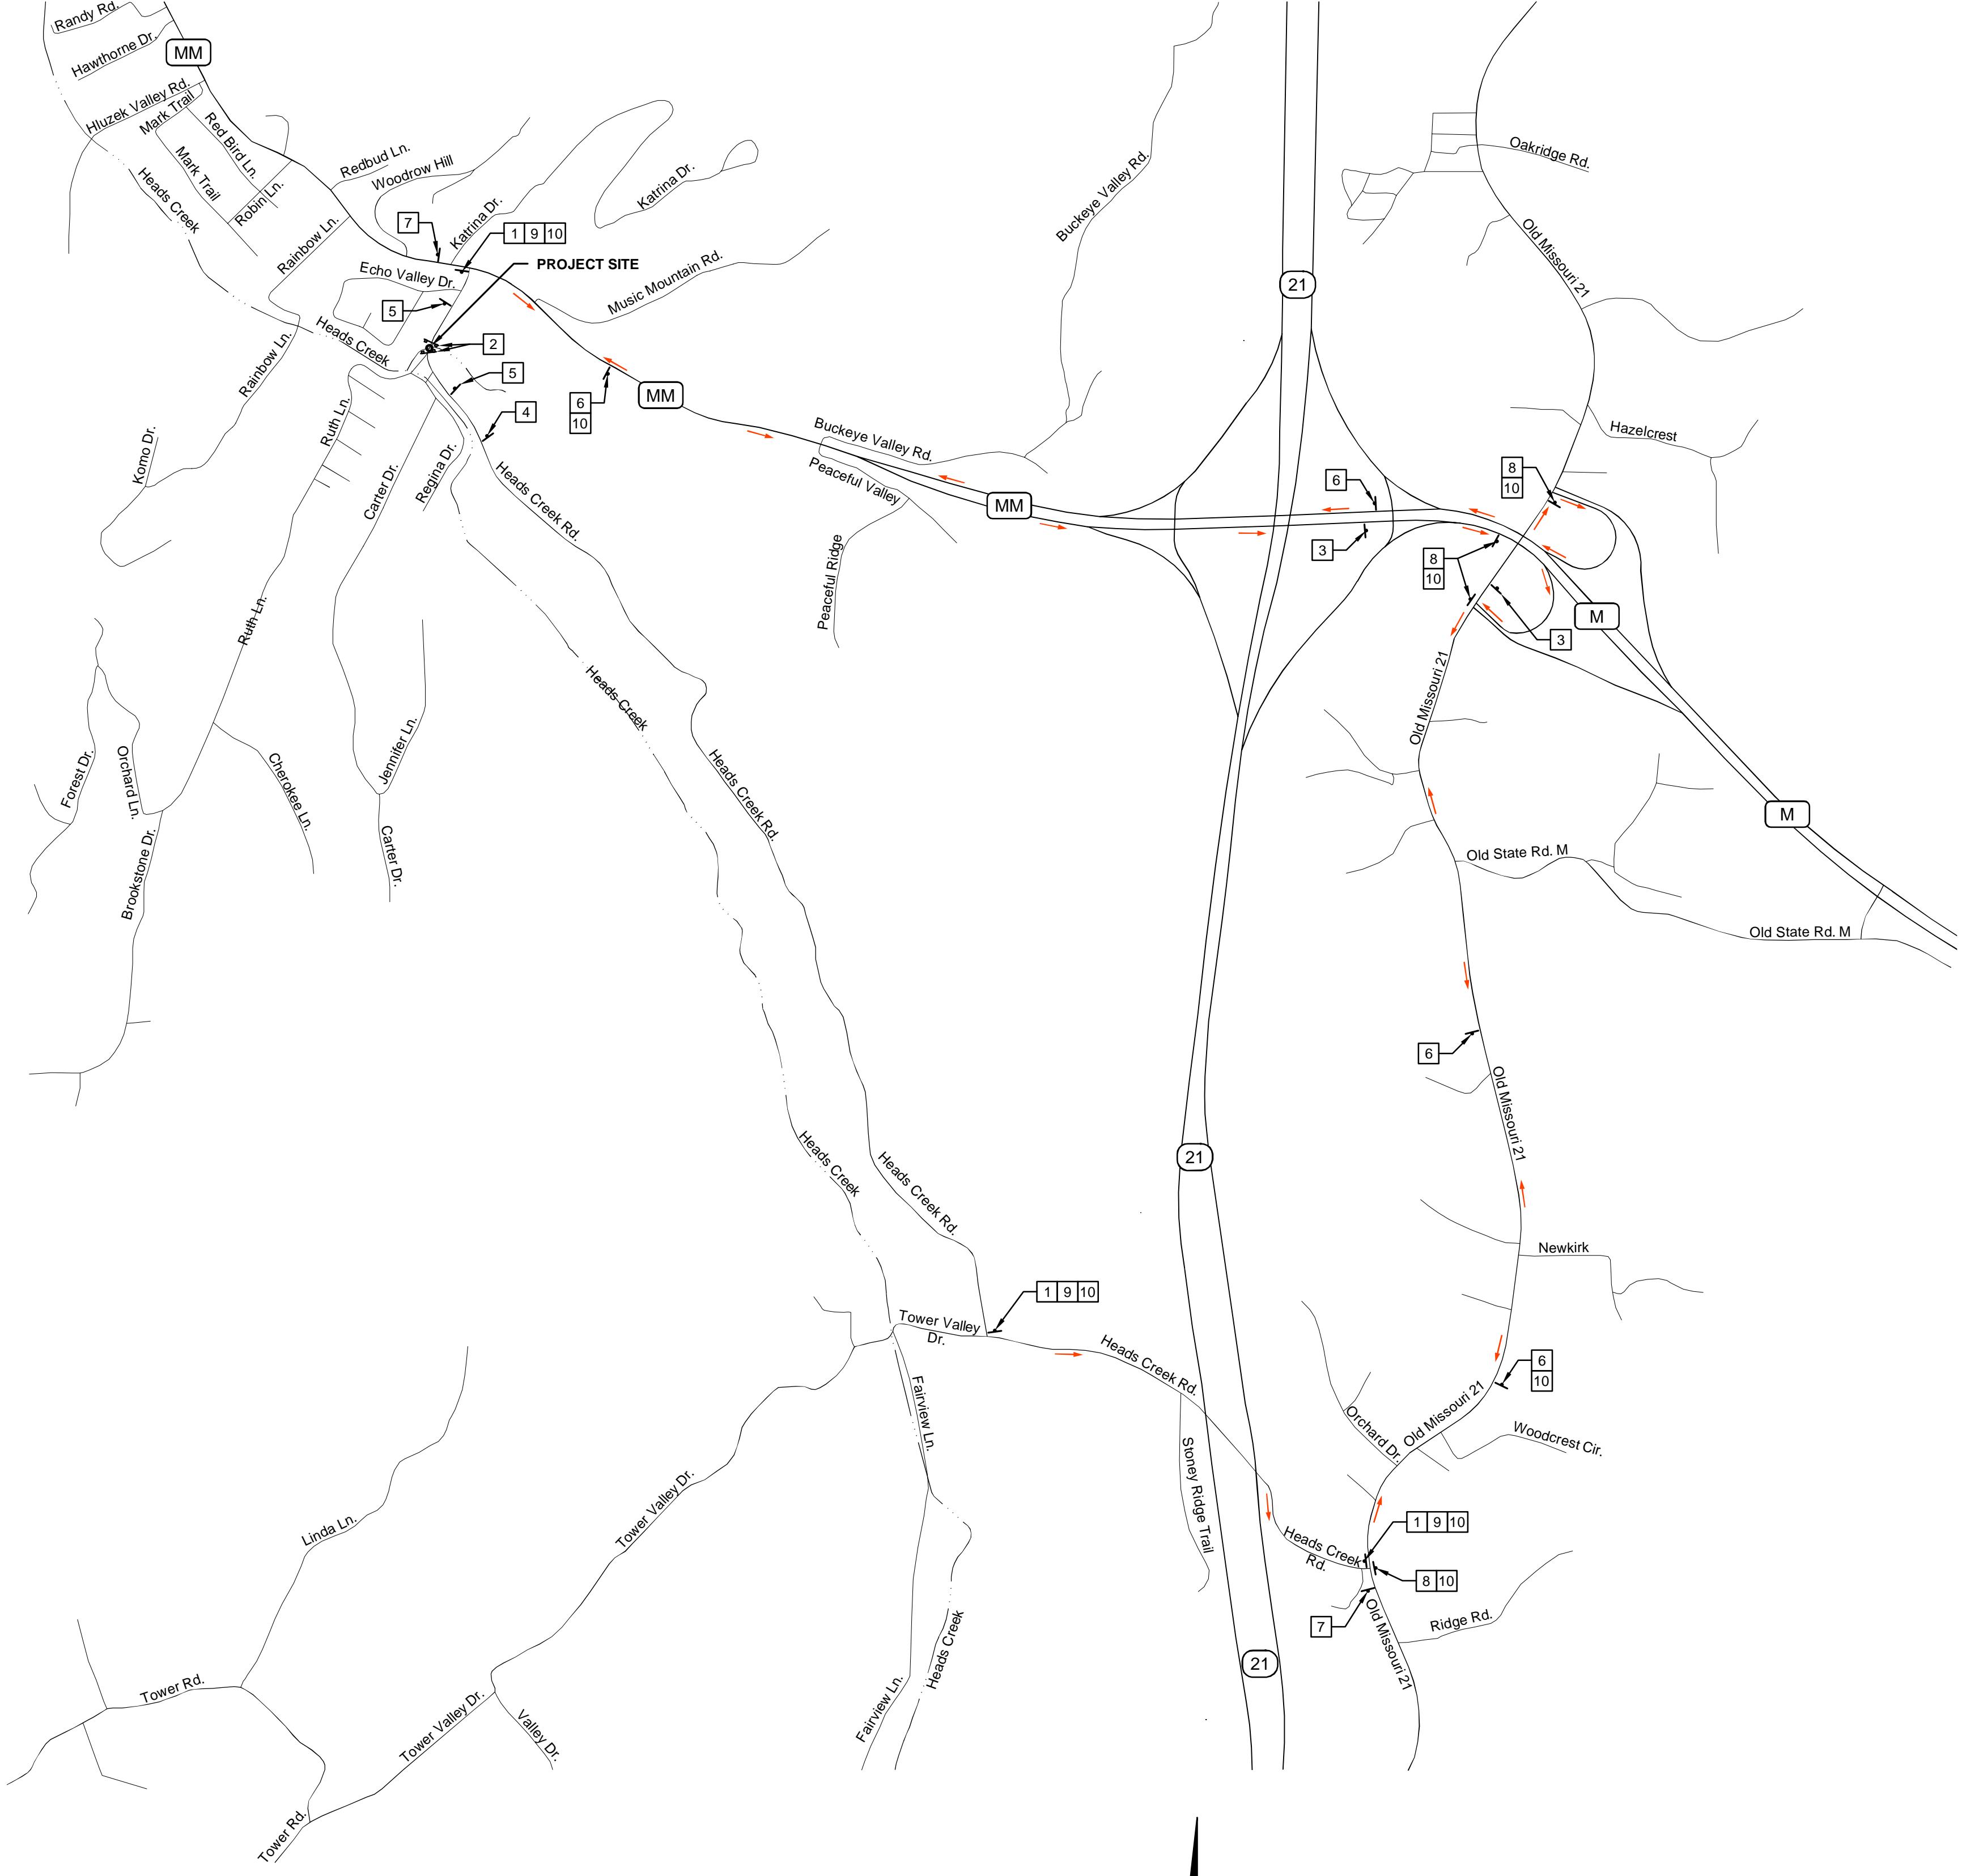

LEGEND:

TEMPORARY TRAFFIC BARRICADE

TRAFFIC DETOUR DIRECTION

TEMPORARY DETOUR SIGN



PLAN
NOT TO SCALE

PLOT SCALE FACTOR 1

BRIDGE OUT XX MILES AHEAD LOCAL TRAFFIC ONLY

GENERAL NOTES:

- CONTRACTOR TO MAINTAIN TRAFFIC CONTROL DURING CONSTRUCTION.
- TRAFFIC CONTROL MAY BE REVISED BY CONTRACTOR PER PUBLIC WORKS DEPARTMENT APPROVAL.
- LOCAL RESIDENTS SHALL HAVE ACCESS TO THEIR DRIVEWAY THROUGHOUT CONSTRUCTION. MAINTAIN ACCESS FOR ALL LOCAL PROPERTY OWNERS DURING CONSTRUCTION.
- ALL SIGNS SHALL BE SIZED FOR CONVENTIONAL ROAD, UNLESS NOTED OTHERWISE.
- ALL SIGNS SHALL CONFORM TO THE CURRENT EDITION OF THE MUTCD.
- CONTRACTOR TO COORDINATE WITH COUNTY BEFORE SIGN PLACEMENT. DISTANCES FOR R11-3b SIGN TO BE DETERMINED BEFORE SIGN PLACEMENT.
- ARROW SIGNS (M4-9 & M4-10) SHALL BE SELECTED (LEFT OR RIGHT OR STRAIGHT AHEAD) IN THE CORRECT DIRECTION OF THE DETOUR ROUTE.
- CHANGEABLE MESSAGE SIGN MAY BE USED AS REQUESTED BY THE COUNTY.

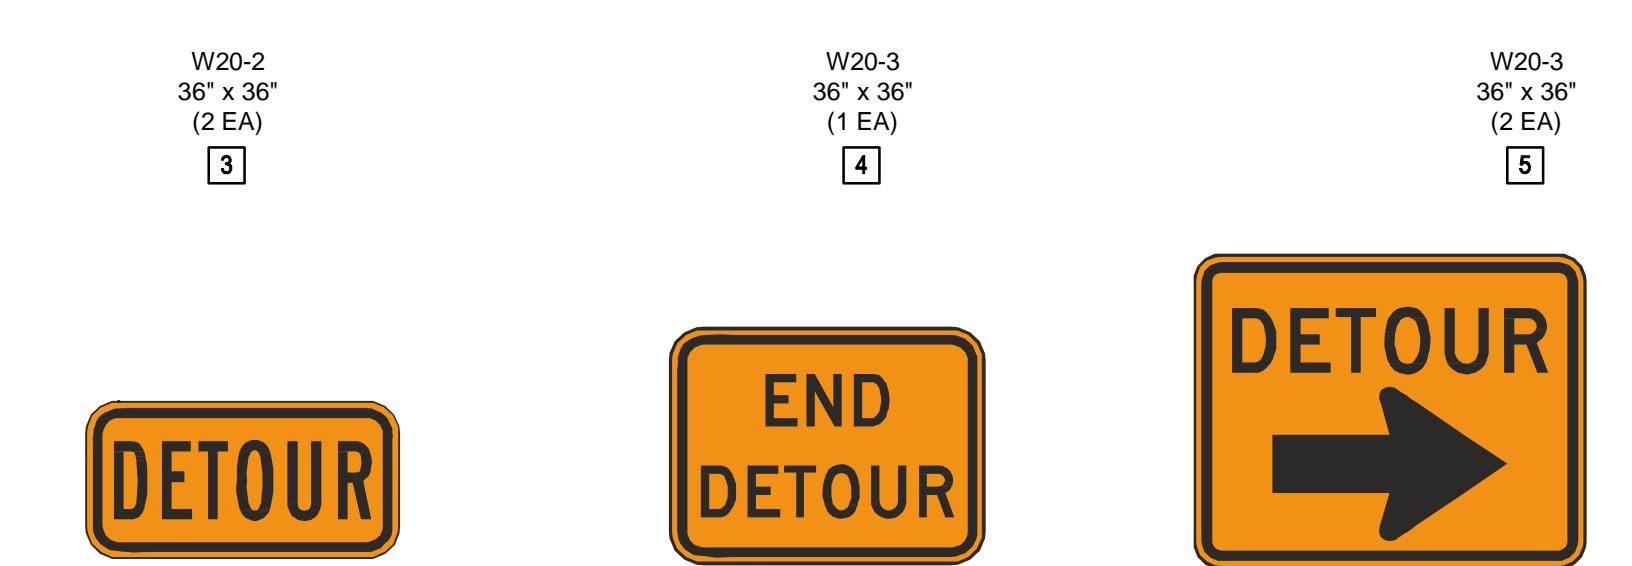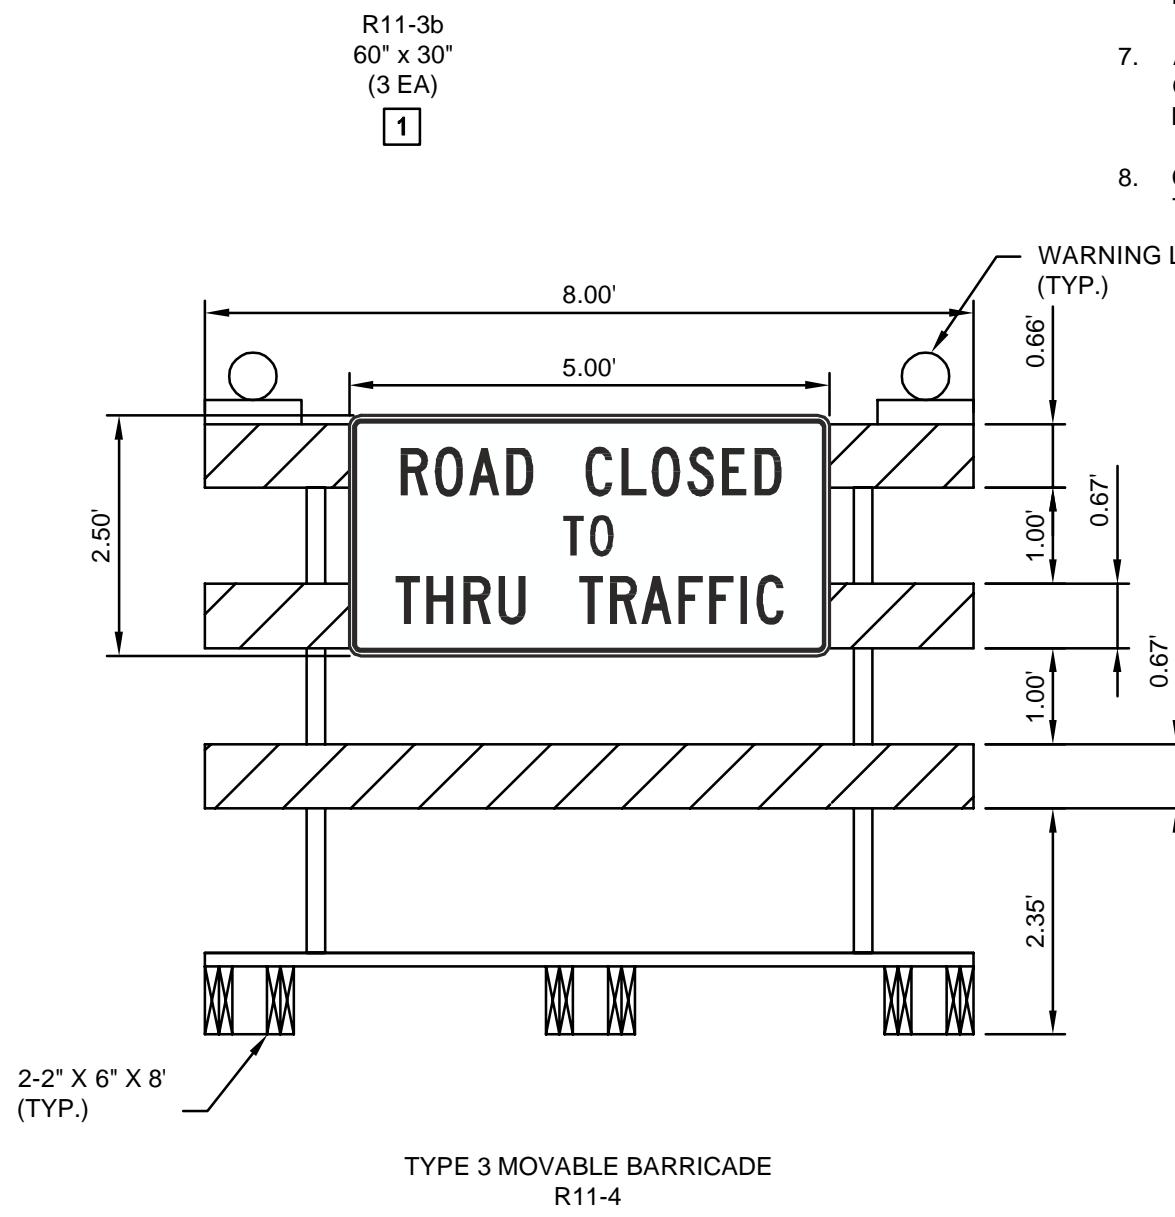

HEADS CREEK ROAD



M4-10 48" x 18" (3 EA)

M4-8 24" x 12" (4 EA)

M4-8a 24" x 18" (2 EA)

D3-1 24" x 12" (8 EA)


01/22/19 ISSUED FOR CONSTRUCTION

0 REV. DATE

DESCRIPTION


APPROVED

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Mvoss
December 21, 2018

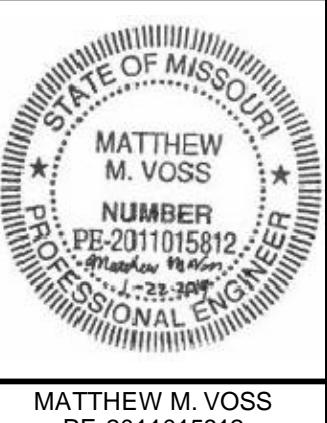DETOUR PLAN
CIVIL DRAWINGS
HEADS CREEK ROAD BRIDGE
JEFFERSON COUNTY, MISSOURI

CDG PROJECT NO.
18013
DRAWING NO.
C-501

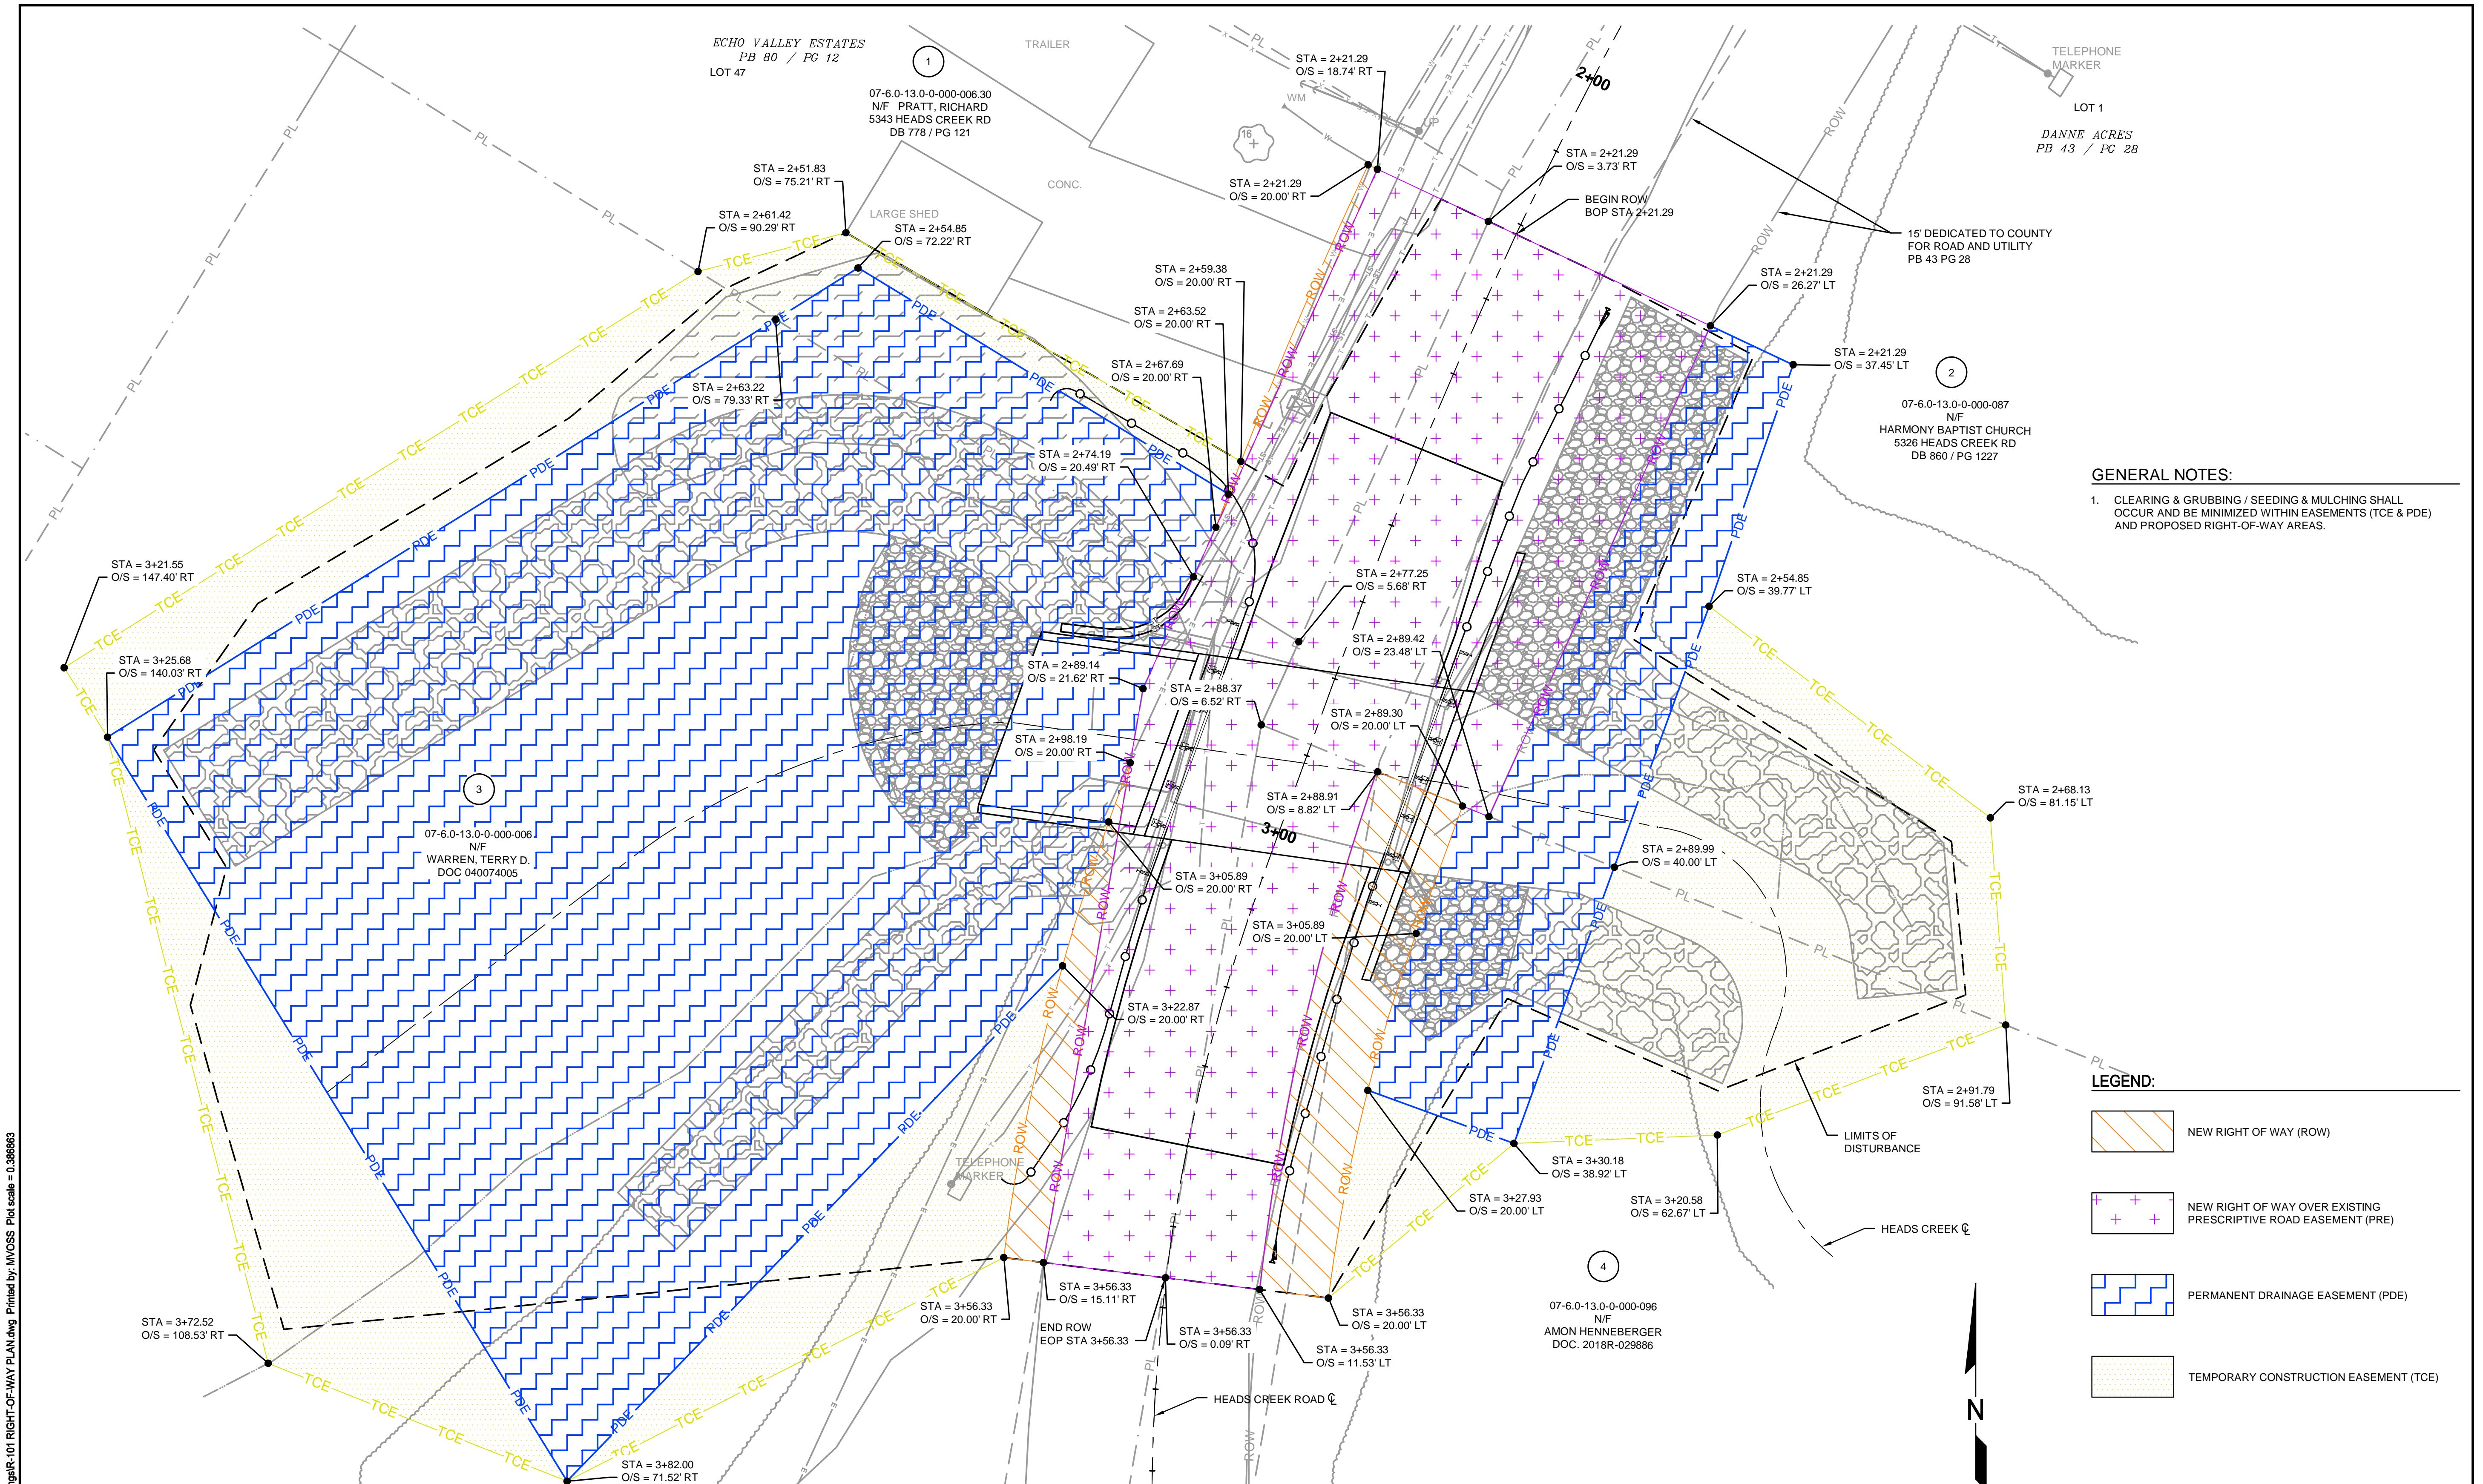

PARCEL #	N/F OWNER NAME	ADDRESS	PARCEL ID	DEED	TOTAL ACRES	ROW	ROW OVER EXISTING PRE	PDE	TCE ACQUISITION	REMANDEE
1	RICHARD PRATT	5343 HEADS CREEK ROAD	07-6-0-13.0-000-006.30	BK: 778 / PG: 121	0.18 AC.	47 SQ.FT. / 0.00 AC.	833 SQ.FT. / 0.02 AC.	608 SQ.FT. / 0.01 AC.	297 SQ.FT. / 0.01 AC.	0.16 AC
2	HARMONY BAPTIST CHURCH	5326 HEADS CREEK ROAD	07-6-0-13.0-0-000-087	BK: 860 / PG: 1227	5.30 AC.	0 SQ.FT. / 0.00 AC.	2001 SQ.FT. / 0.05 AC.	913 SQ.FT. / 0.02 AC.	1287 SQ.FT. / 0.3 AC.	5.25 AC.
3	TERRY D. WARREN	457 COUNTY ROAD 46, MIDLAND, AL	07-6-0-13.0-0-000-006	DOC.#: 040074005	1.57 AC.	231 SQ.FT. / 0.01 AC.	1245 SQ.FT. / 0.03 AC.	10097 SQ.FT. / 0.23 AC.	3036 SQ.FT. / 0.7 AC.	1.54 AC.
4	AMON HENNEBERGER	5555 HEADS CREEK ROAD	07-6-0-13.0-0-000-096	DOC.#: 2018R-029886	16.98 AC.	621 SQ.FT. / 0.01 AC.	807 SQ.FT. / 0.02 AC.	719 SQ.FT. / 0.02 AC.	1326 SQ.FT. / 0.3 AC.	16.95 AC.

RIGHT-OF-WAY & EASEMENT PLA

**RIGHT
SCALE:**

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0	01/22/19	ISSUED FOR CONSTRUCTION	TRN
REV.	DATE	DESCRIPTION	APPROVED

RIGHT-OF-WAY PLAN
COUNTY PROJECT NO. PW19135BXC
HEADS CREEK ROAD BRIDGE
JEFFERSON COUNTY MISSOURI


CDG PROJECT NO.
18013

DRAWING NO.
R-101

SITE BENCHMARK

LARGE NAIL w/ WASHER
ELEVATION - 555.20 (NAVD 88 DATUM)

THE LARGE NAIL IS SET ON THE RIGHT SHOULDER OF HEADS CREEK ROAD BETWEEN RUTH LANE AND HEADS CREEK ROAD; WITHIN THE GRASS AREA, WHICH IS LOCATED APPROXIMATELY 138.00 FEET SOUTH OF THE BOX CULVERT.

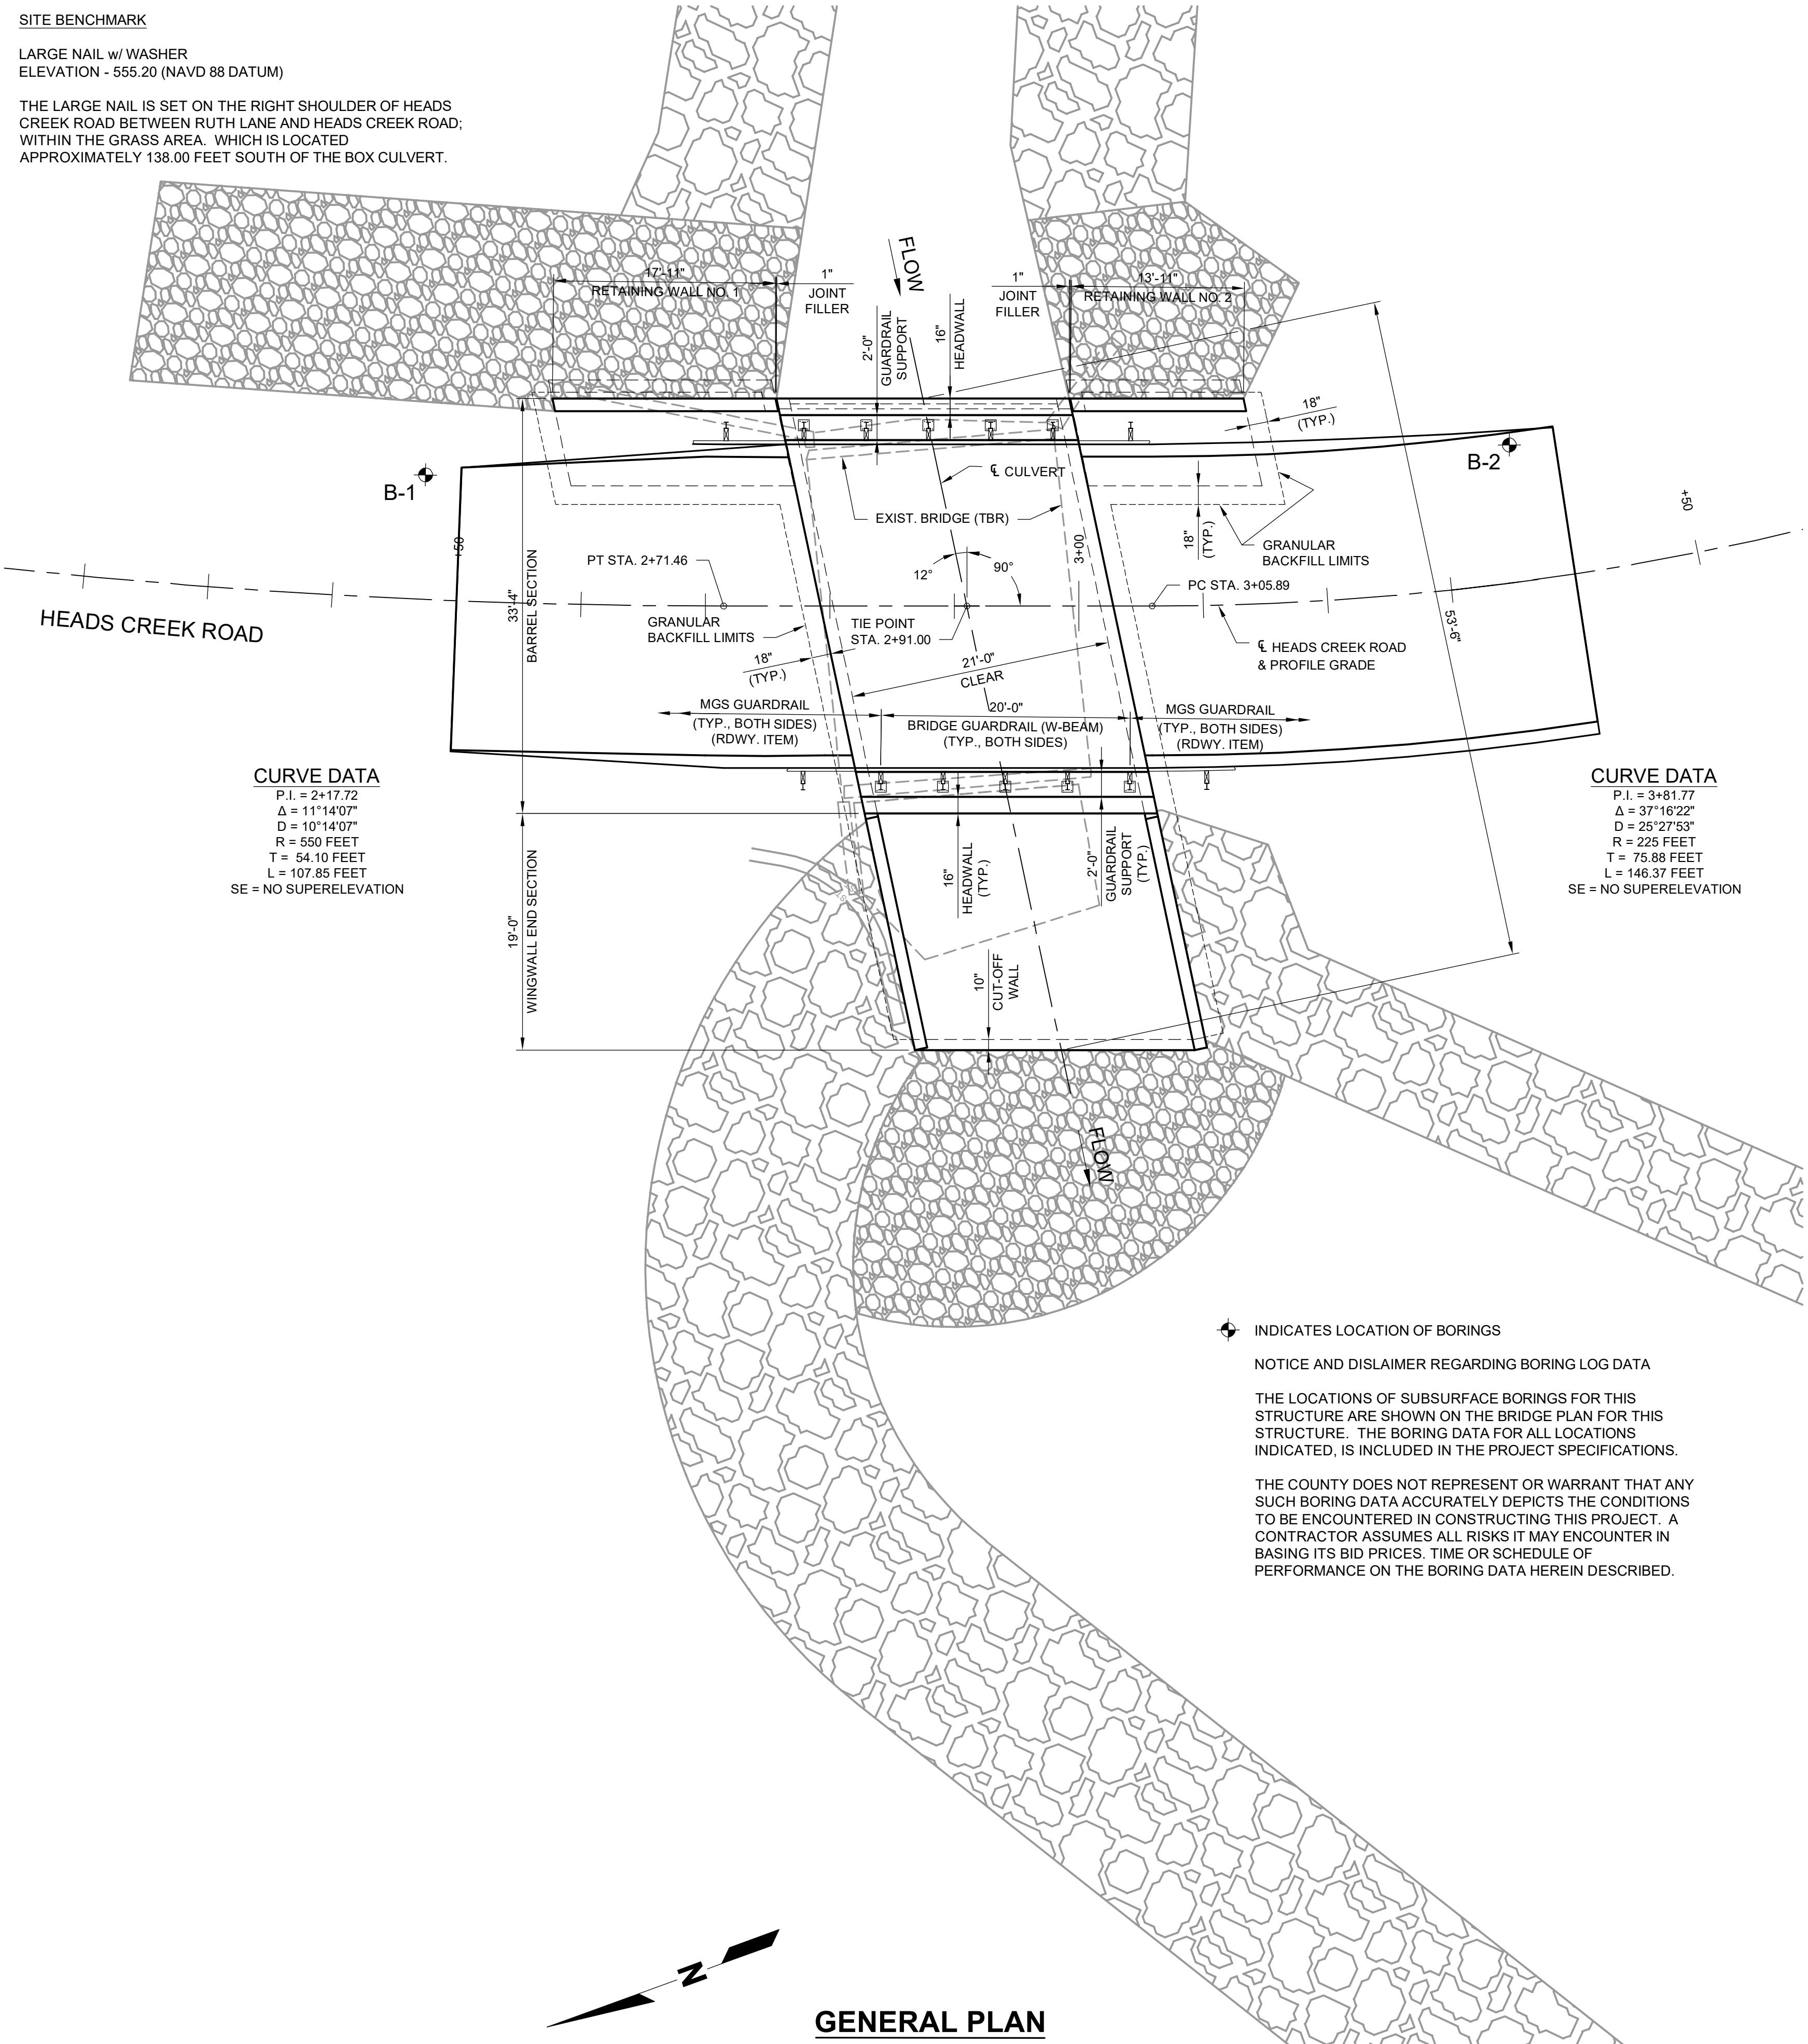

GENERAL NOTES:

DESIGN SPECIFICATIONS:
2012 - AASHTO LRFD BRIDGE DESIGN SPECIFICATIONS (6th EDITION) AND 2013 INTERIM REVISIONS

DESIGN LOADING:
VEHICULAR = HL-93 MINUS LANE LOAD
EARTH 120 LB/CF
EQUIVALENT FLUID PRESSURE 69 LB/CF (RETAINING WALLS)
EQUIVALENT FLUID PRESSURE 30 LB/CF (MIN.), 69 LB/CF (MAX) (BOX CULVERT)

DESIGN UNIT STRESSES:
CLASS B-1 CONCRETE (BOX CULVERT) $f_c = 4,000$ psi
CLASS B-1 CONCRETE (RETAINING WALLS) $f_c = 4,000$ psi
REINFORCING STEEL (GRADE 60) $fy = 60,000$ psi

MATERIALS:
REINFORCING STEEL: MINIMUM CLEARANCE TO REINFORCING STEEL SHALL BE 1 1/2", UNLESS OTHERWISE SHOWN. THE USE OF AUTOMATIC TIE GUNS SHALL NOT BE PERMITTED. ALL STEEL SHALL BE TIED 100%.

JOINT FILLER:
ALL JOINT FILLER SHALL BE IN ACCORDANCE WITH SEC 1057 FOR PREFORMED SPONGE RUBBER EXPANSION AND PARTITION JOINT FILLER, EXCEPT AS NOTED.

MISCELLANEOUS:
WHEN ALTERNATE PRECAST CONCRETE BOX CULVERT SECTIONS ARE USED, THE MINIMUM DISTANCE FROM INSIDE FACE OF HEADWALLS TO PRECAST SECTIONS MEASURED ALONG THE SHORTEST WALL SHALL BE 3 FEET. REINFORCEMENT AND DIMENSIONS FOR WINGS AND HEADWALLS SHALL BE IN ACCORDANCE WITH MISSOURI STANDARD PLANS EXCEPT AS OTHERWISE SHOWN HEREIN.

sheet B-102 (SECTION THRU BARREL) SHOWS A SINGLE CELL RECTANGULAR BOX CULVERT WITH A CLEAR WIDTH OF 21'-0" AND A CLEAR HEIGHT OF 7'-0". ALTERNATE SINGLE CELL BOX CULVERT CONFIGURATIONS USING CORNER HAUNCHES AND PROVIDING THE SAME EFFECTIVE WATERWAY OPENING WILL BE ALLOWED. THE CONTRACTOR SHALL SUBMIT DRAWINGS, DESIGN CALCULATIONS AND LOAD RATING CALCULATIONS, SIGNED AND SEALED BY A MISSOURI REGISTERED PROFESSIONAL ENGINEER, A MINIMUM OF 3 WEEKS PRIOR TO FABRICATION OF THE BOX CULVERT TO THE COUNTY FOR REVIEW AND APPROVAL.

ANY CHANGES TO THE PROJECT DESIGN OR DETAILS NECESSARY TO ACCOMMODATE THE CONTRACTOR'S ALTERNATE STRUCTURE SHALL BE THE SOLE RESPONSIBILITY OF THE CONTRACTOR. NO ADDITIONAL COMPENSATION WILL BE ALLOWED FOR THIS CHANGE. COMPENSATION WILL BE MADE AT THE CONTRACT UNIT PRICES FOR THE ORIGINAL PAY ITEMS AND QUANTITIES SHOWN IN THE PLANS UNLESS ERRORS ARE FOUND OR OTHER ADJUSTMENTS ARE APPROVED BY THE COUNTY.

FILL MATERIAL UNDER THE SLAB SHALL BE FIRMLY TAMPED BEFORE THE SLAB IS POURED.

IF UNSUITABLE MATERIAL IS ENCOUNTERED, EXCAVATION OF UNSUITABLE MATERIAL AND FURNISHING AND PLACING OF GRANULAR BACKFILL SHALL BE IN ACCORDANCE WITH SEC 206.

CHANNEL BOTTOM SHALL BE GRADED FOR TRANSITION OF CHANNEL BED TO CULVERT OPENINGS. CHANNEL BANKS SHALL BE TAPERED TO MATCH CULVERT OPENINGS. (RDWY. ITEM).

SEC REFERS TO SECTIONS IN THE MISSOURI STANDARD AND SUPPLEMENTAL SPECIFICATIONS FOR HIGHWAY CONSTRUCTION UNLESS SPECIFIED OTHERWISE.

TRAFFIC HANDLING: ROAD CLOSED DURING CONSTRUCTION. SEE ROADWAY PLANS FOR TRAFFIC CONTROL.

CONSTRUCTION SPECIFICATIONS:
THE 2018 EDITION OF THE MoDOT'S "MISSOURI STANDARD SPECIFICATIONS FOR HIGHWAY CONSTRUCTION" AND THE JOB SPECIFICATIONS SHALL GOVERN.



HYDROLOGIC DATA

DRAINAGE AREA = 2.8 SQ. MILES
DESIGN DISCHARGE = 2860 CU. FT. / SEC. (100 YEAR)
U/S DESIGN H.W. ELEVATION = 560.01 (100 YEAR)

TABLE OF ESTIMATED STRUCTURE QUANTITIES

ITEM	UNIT	ESTIMATED	FINAL
CLASS 4 EXCAVATION	CU. YARD	350	
GRANULAR BACKFILL	CU. YARD	61	
REMOVAL OF BRIDGES	LUMP SUM	1	
CLASS B-1 CONCRETE (RETAINING WALLS)	CU. YARD	28.1	
CLASS B-1 CONCRETE (CULVERTS-BRIDGE)	CU. YARD	131.4	
REINFORCING STEEL (CULVERTS-BRIDGE)	POUND	12430	
REINFORCING STEEL (RETAINING WALLS)	POUND	5520	
REINFORCING STEEL (EPOXY COATED)	POUND	8830	
BRIDGE GUARDRAIL (W-BEAM)	LIN. FOOT	40	

0	01/23/19	ISSUED FOR CONSTRUCTION
REV.	DATE	DESCRIPTION
		APPROVED

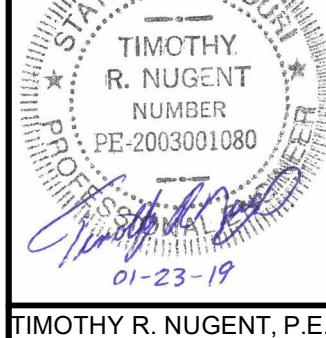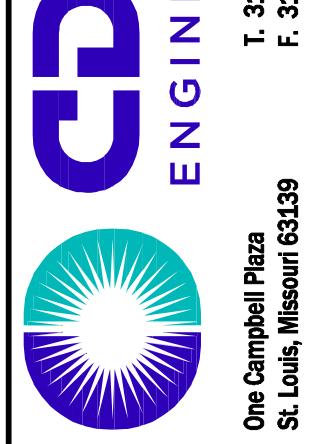

Tnugent
January 23, 2019

GENERAL PLAN & ELEVATION
COUNTY PROJECT NO. PW19135BX
HEADS CREEK ROAD BRIDGE
JEFFERSON COUNTY, MISSOURI

CDG PROJECT NO.
18013
DRAWING NO.
B-101

RETAINING WALL NO. 1

HEADS CREEK ROAD

PT STA. 2+71.46

CULVERT

PC STA. 3

TIE POINT STA. 2+91.00

FLOW

TOP SLAB

DETAIL A

HEADWALL (TYP.)

16"

RETAINING WALL NO. 1

HEADS CREEK & PROFILE GRA

POINT NUMBER

TOP OF TOP SLAB ELEVATION

TOP OF GUARDRAIL SUPPORT ELEVATION

TOP OF HEADWALL ELEVATION


TOP OF ASPHALT TOPPING ELEVATION

POINT NUMBER	TOP OF TOP SLAB ELEVATION	TOP OF GUARDRAIL SUPPORT ELEVATION	TOP OF HEADWALL ELEVATION	TOP OF ASPHALT TOPPING ELEVATION
1	---	557.20	557.70	---
2	---	557.15	557.70	---
3	---	557.09	557.70	---
4	556.89	557.24	---	557.24
5	556.89	557.18	---	557.18
6	556.89	557.13	---	557.13
7	556.68	---	---	557.49
8	556.68	---	---	557.44
9	556.68	---	---	557.39
10	556.45	557.21	---	557.21
11	556.45	557.16	---	557.16
12	556.45	557.10	---	557.10
13	---	557.17	557.68	---
14	---	557.12	557.68	---
15	---	557.06	557.68	---

TABLE OF KEY POINT ELEVATIONS


TABLE OF KEY POINT ELEVATIONS				
POINT NUMBER	TOP OF TOP SLAB ELEVATION	TOP OF GUARDRAIL SUPPORT ELEVATION	TOP OF HEADWALL ELEVATION	TOP OF ASPHALT TOPPING ELEVATION
1	---	557.20	557.70	---
2	---	557.15	557.70	---
3	---	557.09	557.70	---
4	556.89	557.24	---	557.24
5	556.89	557.18	---	557.18
6	556.89	557.13	---	557.13
7	556.68	---	---	557.49
8	556.68	---	---	557.44
9	556.68	---	---	557.39
10	556.45	557.21	---	557.21
11	556.45	557.16	---	557.16
12	556.45	557.10	---	557.10
13	---	557.17	557.68	---
14	---	557.12	557.68	---
15	---	557.06	557.68	---

PLAN SHOWING KEY POINT ELEVATIONS

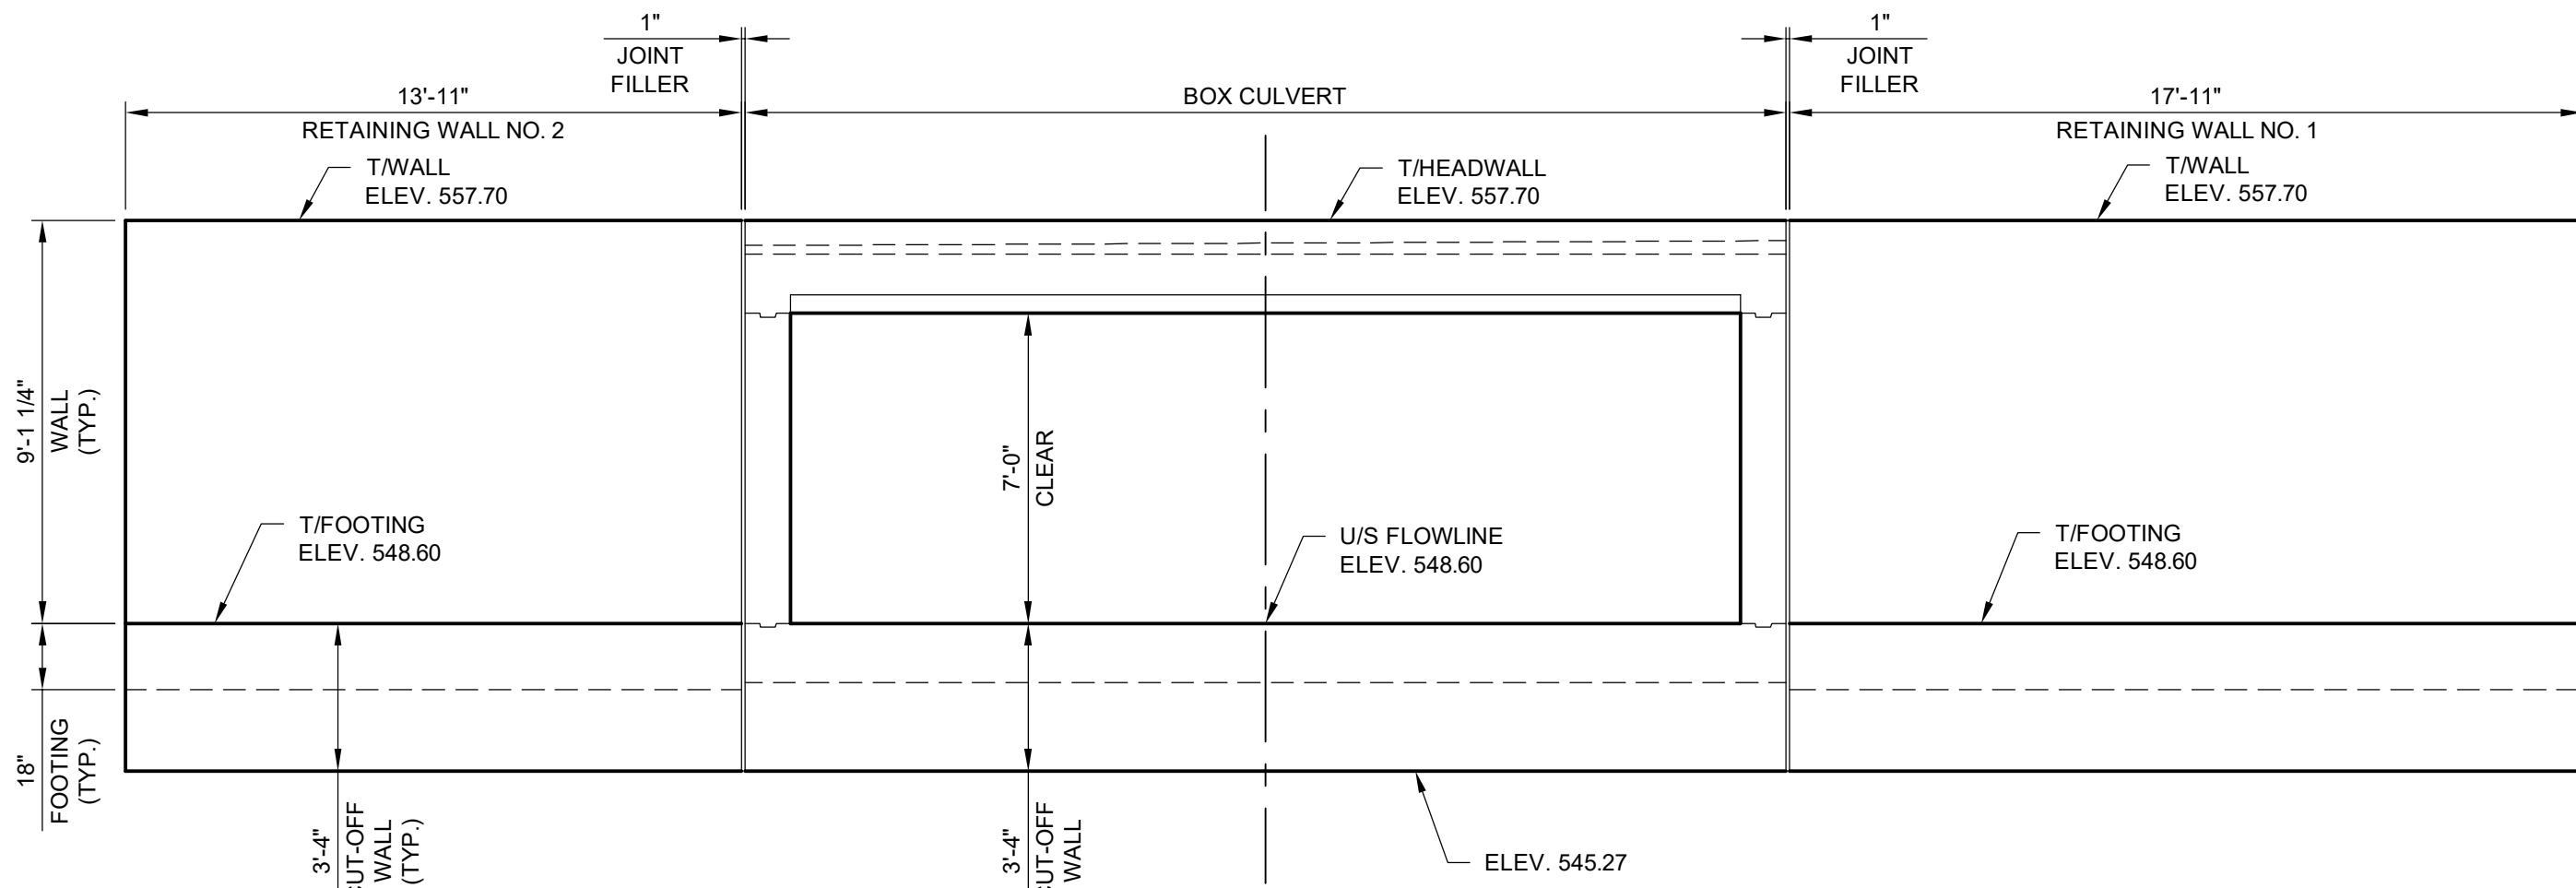


ELEVATION AT UPSTREAM FACE

(LOOKING WE)

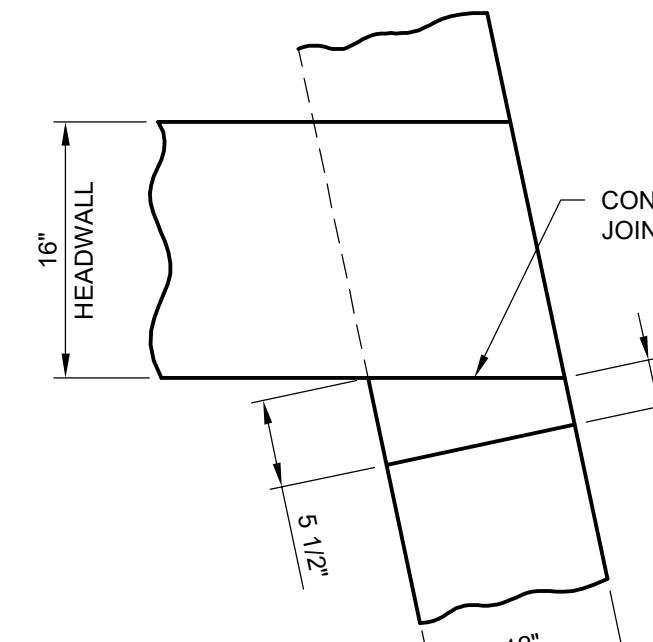

DETAIL A

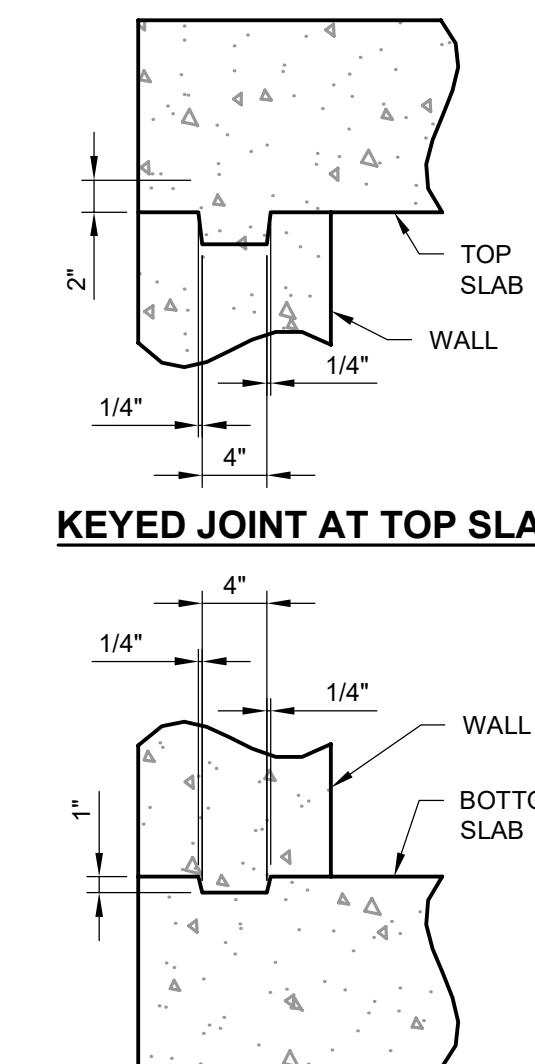

KEYED JOINT AT BOTTOM SLAB

CONSTRUCTION

JOINT DETAILS

NOTES:


SEE DRAWING B-103 CULVERT ELEVATION AND SECTION THRU WINGWALL END SECTION.

SEE DRAWINGS B-104 & B-105 FOR DETAILS OF RETAINING WALLS NO. 1 & 2.


SEE DRAWING B-106 FOR PLAN SHOWING BOTTOM SLAB REINFORCEMENT.

SEE DRAWING B-107 FOR PLAN SHOWING TOP SLAB REINFORCEMENT.

SEE DRAWING B-108 FOR GUARDRAIL POST LOCATIONS AND DETAILS.

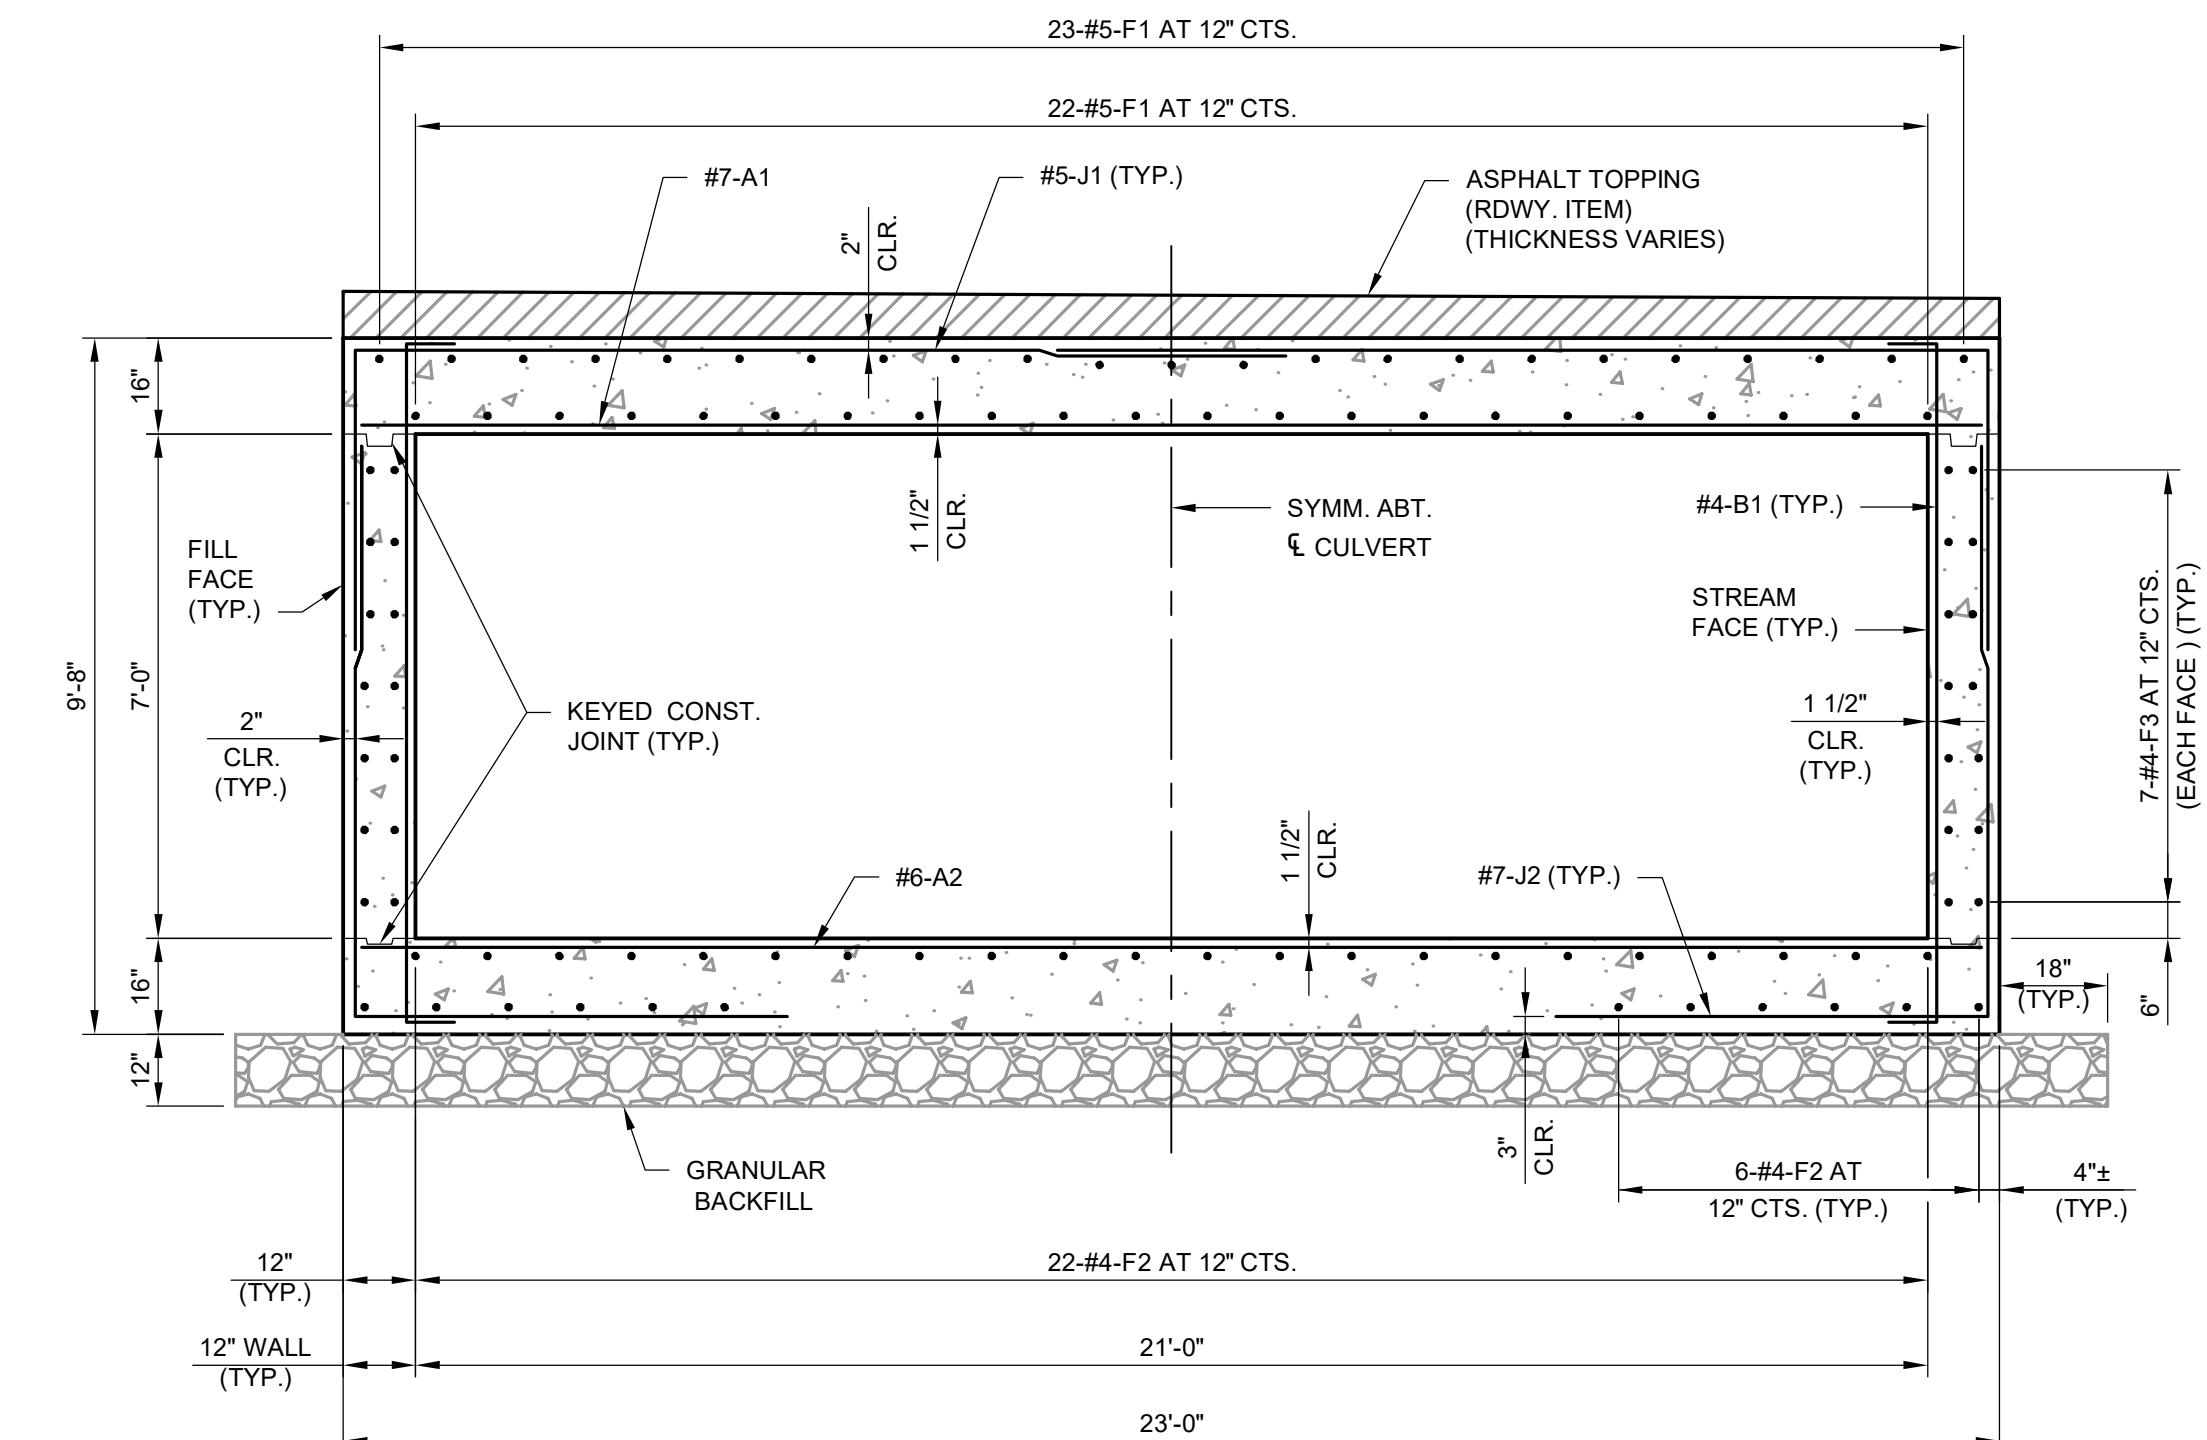



SECTION THRU BARREL

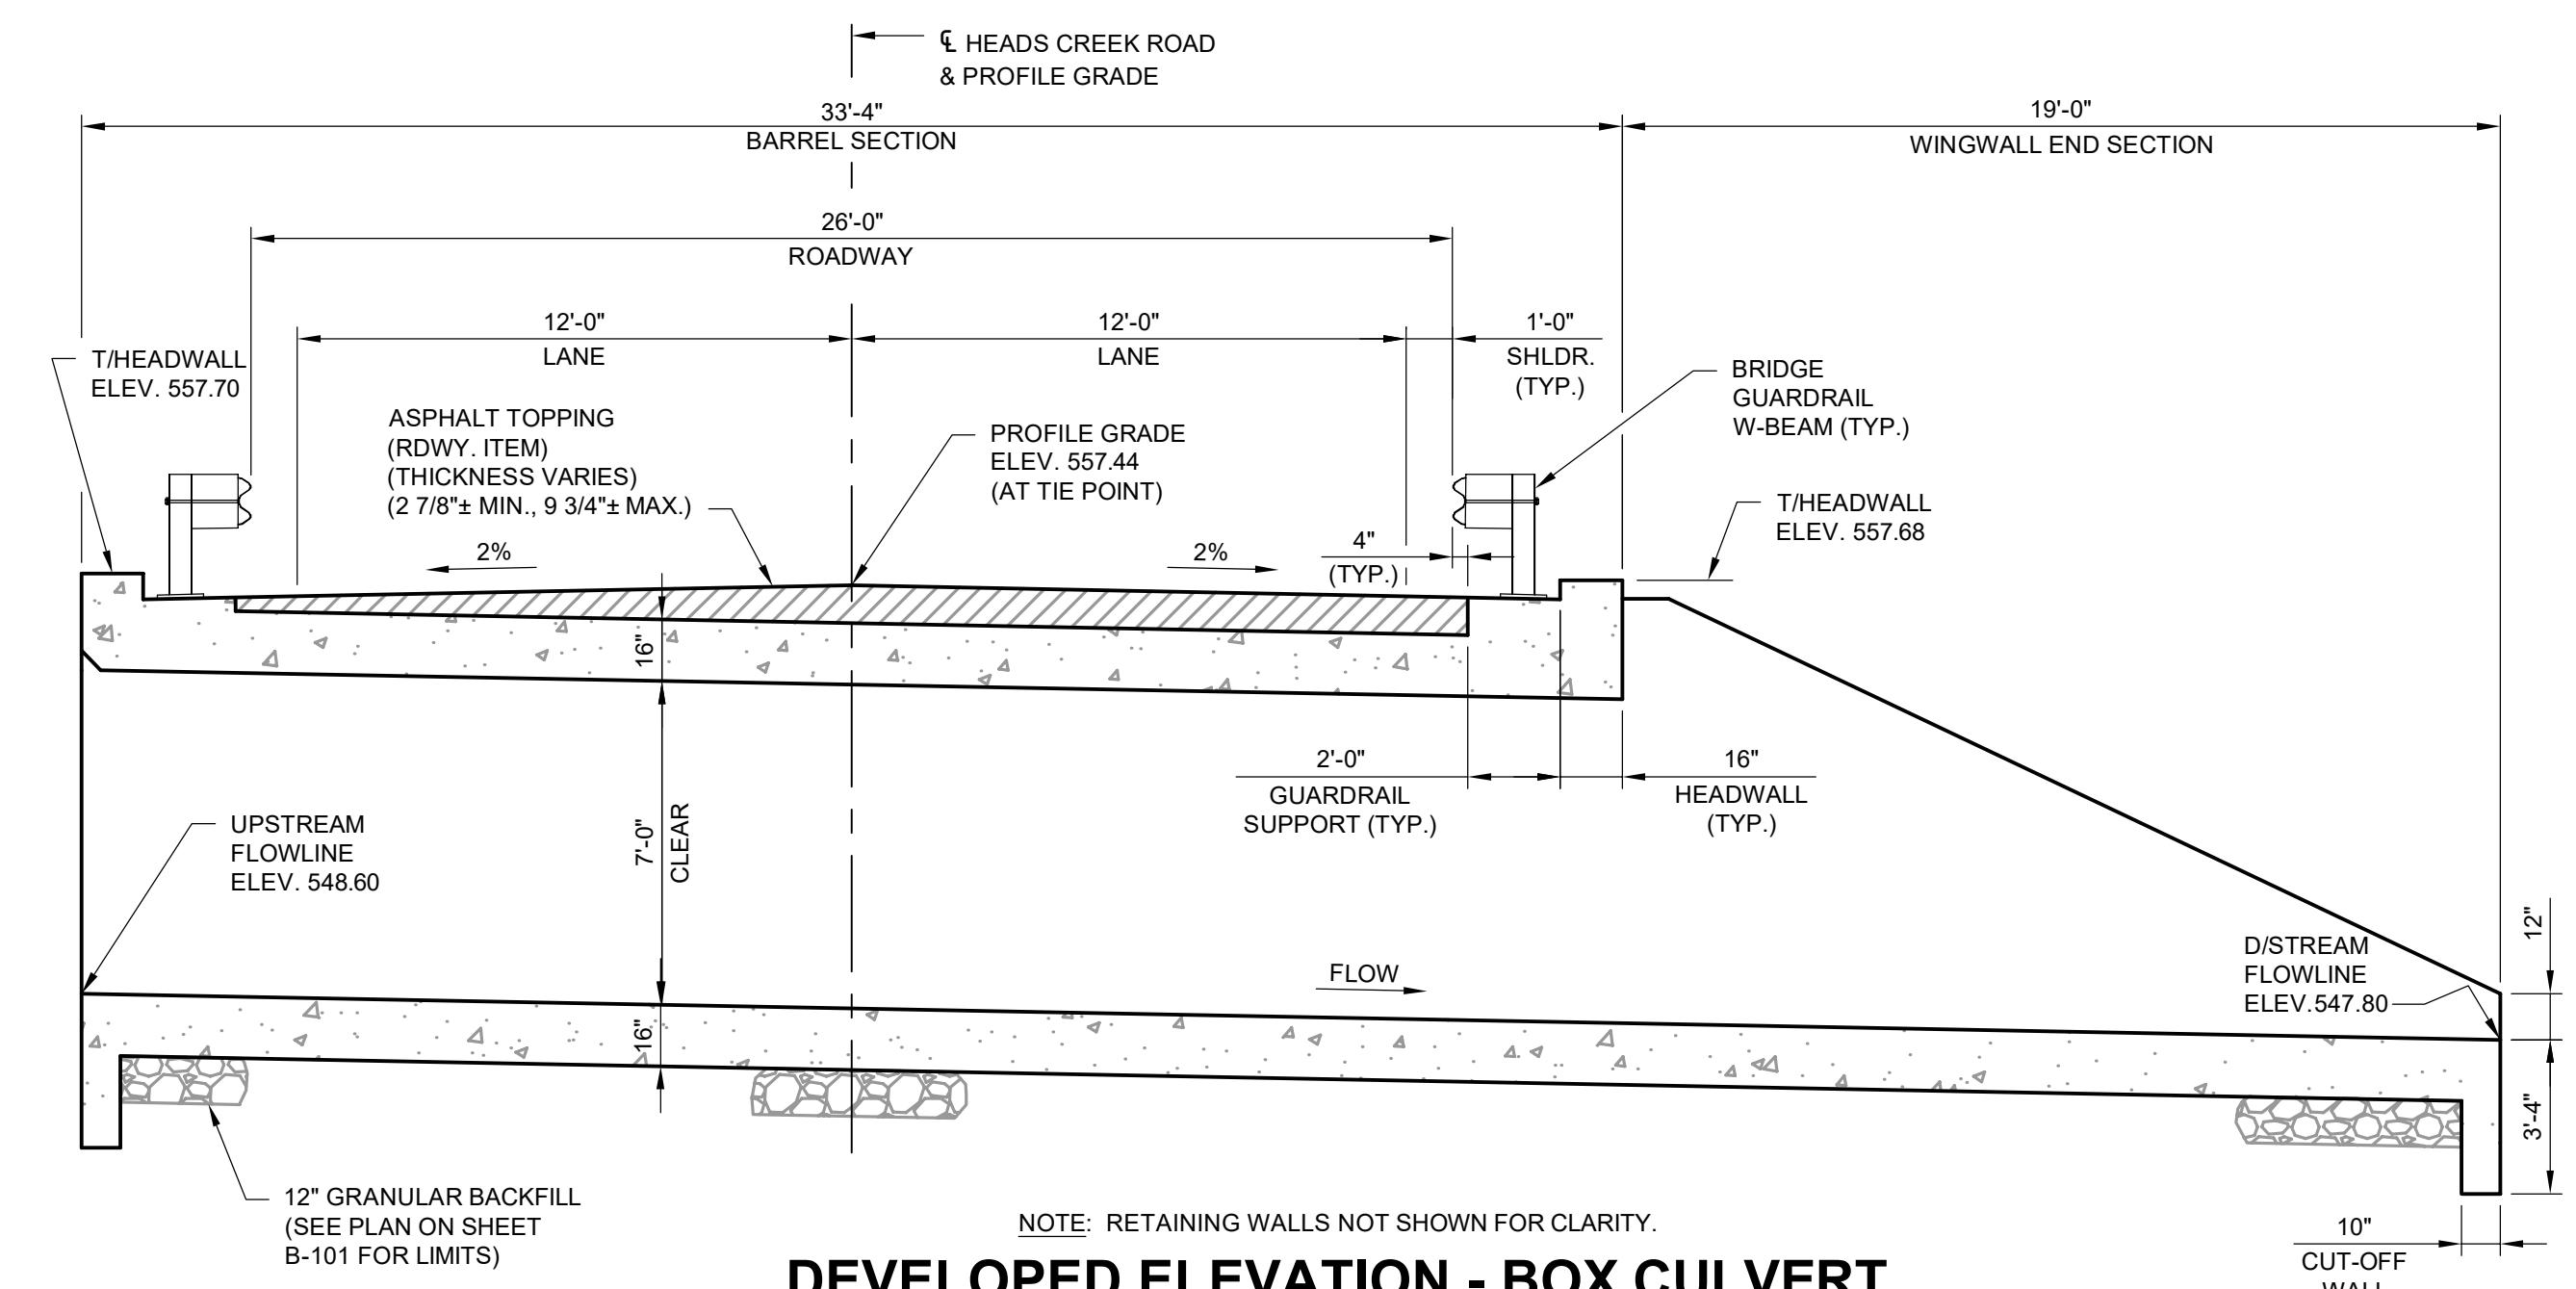

DEVELOPED ELEVATION - BOX CULVERT

(PERPENDICULAR TO ROADWAY CENTERLINE)

0	01/23/19	ISSUED FOR CONSTRUCTION	TRN
REV.	DATE	DESCRIPTION	APPROVE

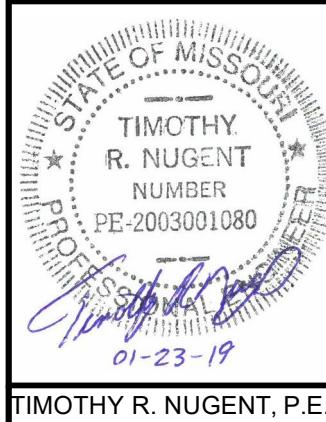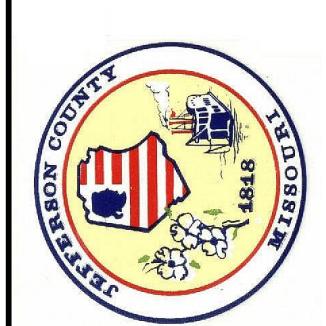


**CULVERT PLAN, ELEVATIONS & SECTIONS
COUNTY PROJECT NO. PW19135BXC
HEADS CREEK ROAD BRIDGE
JEFFERSON COUNTY, MISSOURI**

CDG PROJECT NO.


DRAWING NO.

B 102

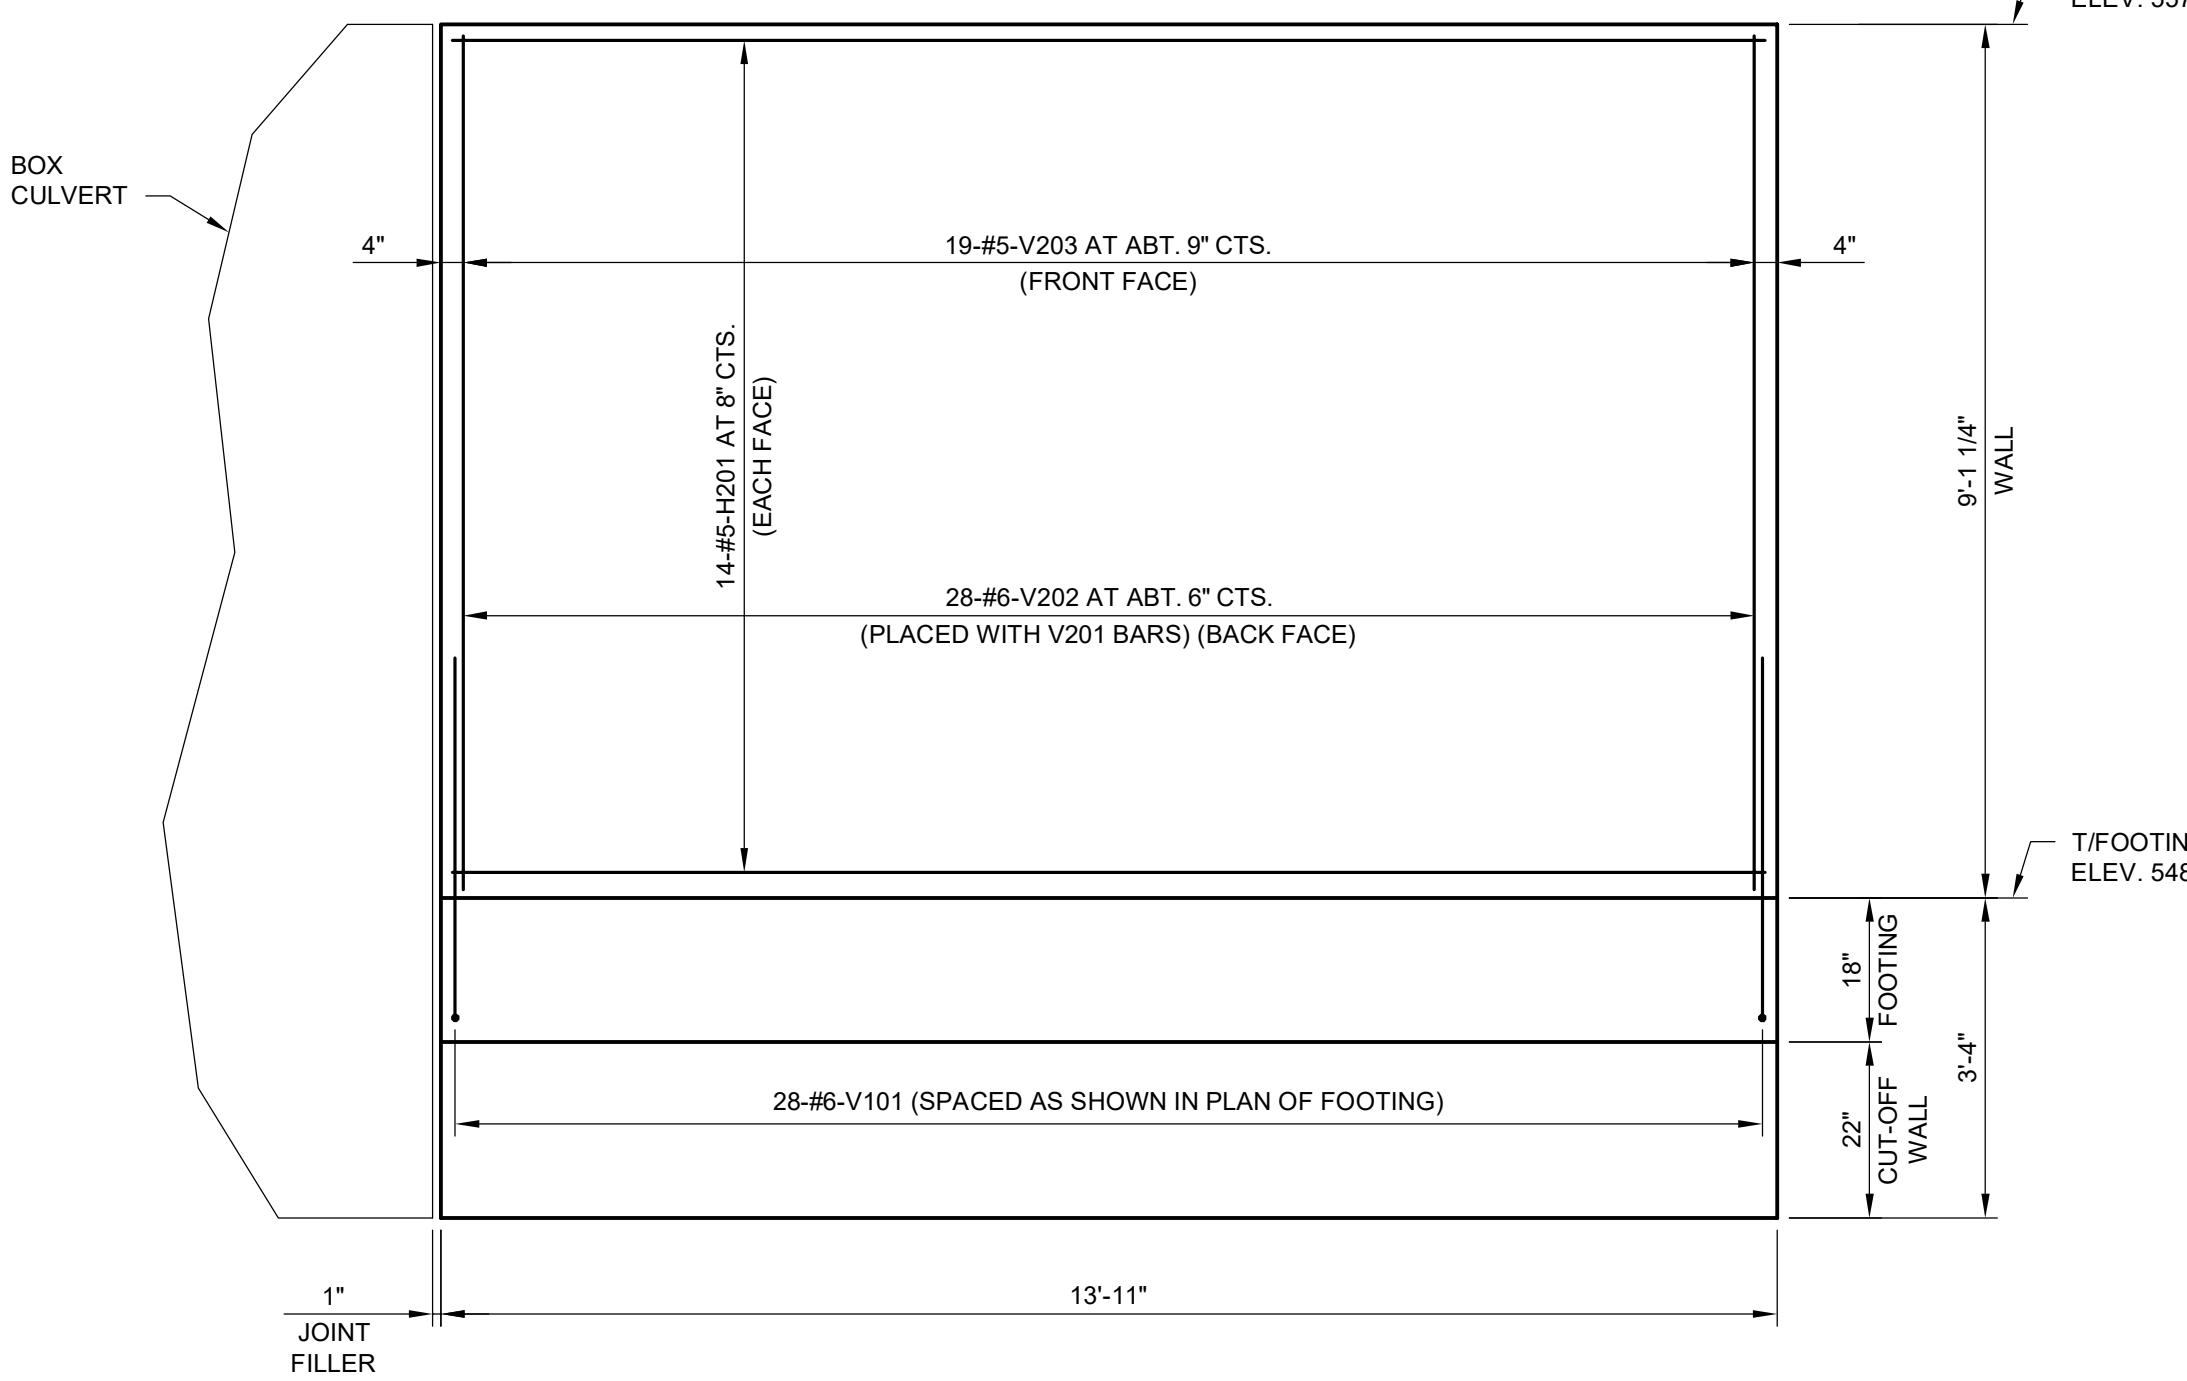

NOTE: FOOTING AND CUT-OFF WALL REINFORCEMENT NOT SHOWN FOR CLARITY.

RETAINING WALL NO. 2 - ELEVATION SHOWING WALL REINFORCEMENT

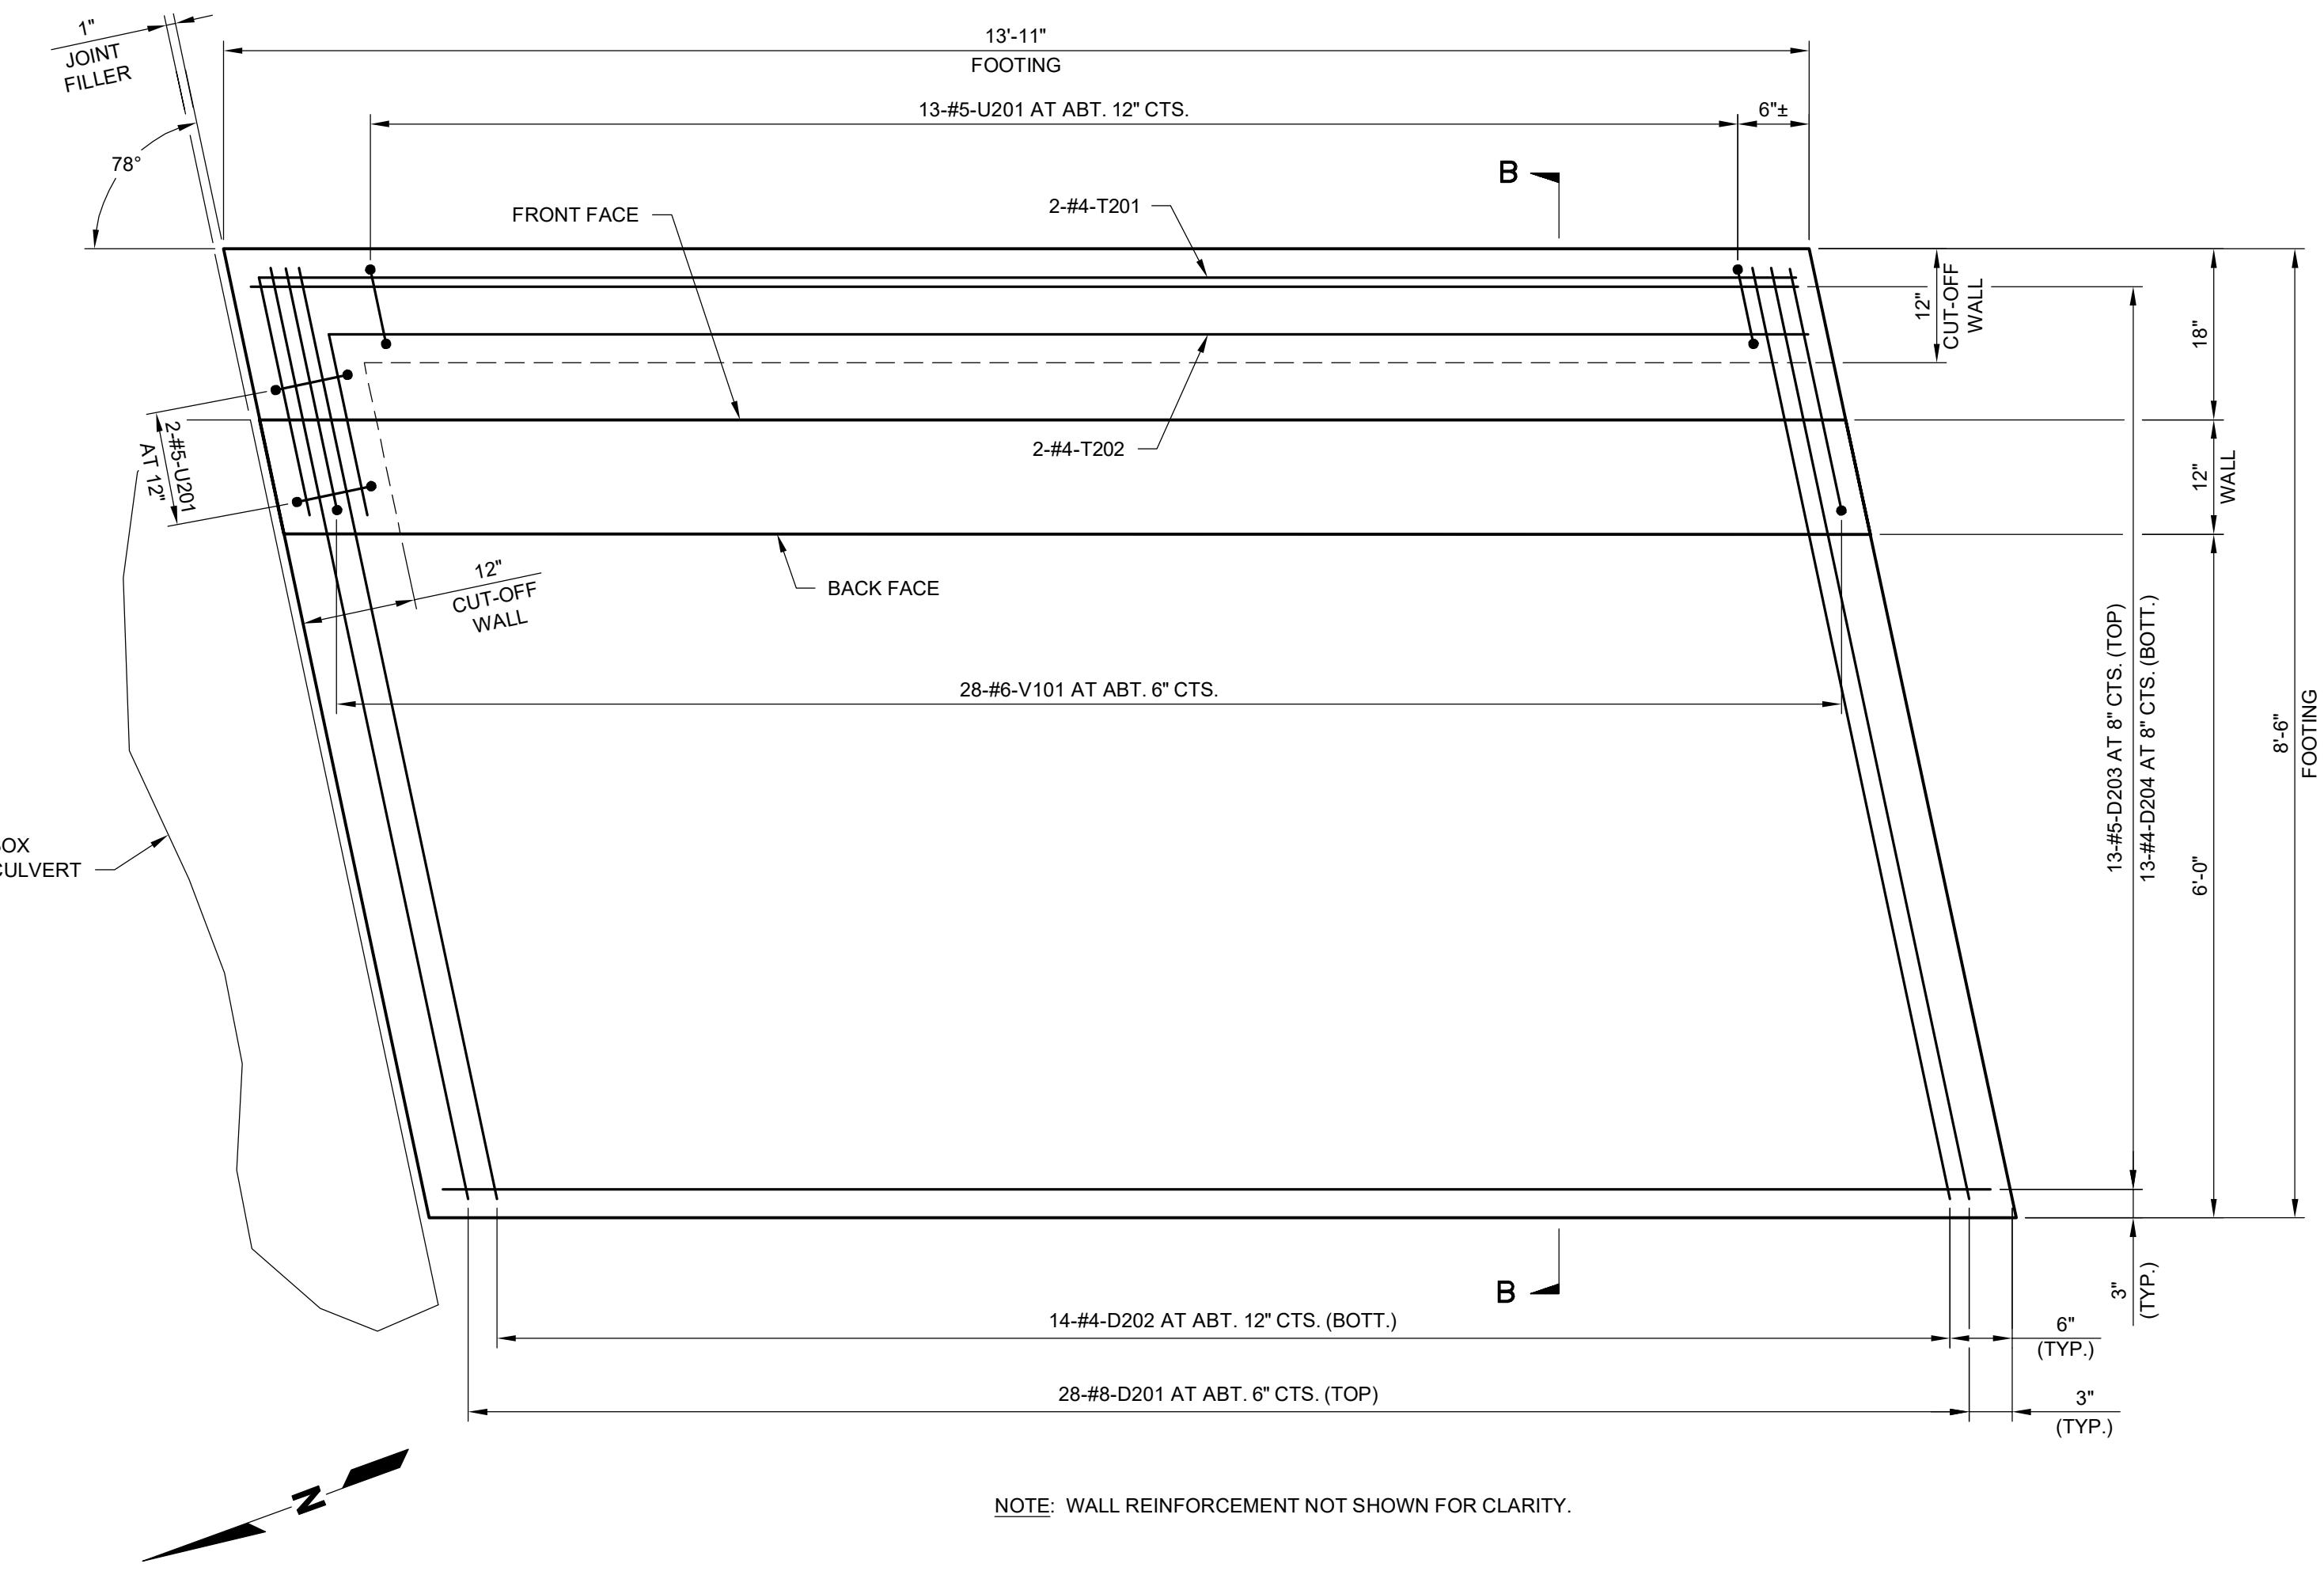

RETAINING WALL NO. 2 - PLAN OF FOOTING SHOWING REINFORCEMENT

T:\Working\18013 - JeffCo - Heads Creek Bridge\Drawings\Bridge Final Plans.dwg
tnugent 01/23/19-16:08

NOTE: THIS DRAWING IS NOT TO SCALE. FOLLOW DIMENSIONS.

PLOT SCALE FACTOR 1


NOTES:

SEE DRAWING B-104 FOR CONSTRUCTION JOINT DETAIL AND DETAIL AT BOX CULVERT AND RETAINING WALL.

PAYMENT FOR FURNISHING AND INSTALLING THE 3-INCH DIAMETER WEEPHOLES INCLUDING POROUS BACKFILL, 4 GAUGE GALVANIZED SCREENS, ALL LABOR AND EQUIPMENT, AND ANY OTHER INCIDENTAL WORK NECESSARY FOR A COMPLETE INSTALLATION WILL BE CONSIDERED COMPLETELY COVERED BY THE CONTRACT UNIT PRICE FOR OTHER ITEMS.

SEPARATION GEOTEXTILE SHALL BE APPLIED TO THE JOINTS BETWEEN THE RETAINING WALLS AND THE BOX CULVERT. THE EDGES SHALL BE SEALED WITH A MASTIC OR TWO-SIDED TAPE. THE COST FOR FURNISHING AND INSTALLING THE SEPARATION GEOTEXTILE WILL BE CONSIDERED COMPLETELY COVERED BY THE CONTRACT UNIT PRICE FOR OTHER ITEMS.


The logo for CDG Engineers. It features a large, bold, blue 'CDG' monogram on the left. To the right of the monogram, the word 'ENGINEERS' is written vertically in blue capital letters. Below the monogram is a circular graphic composed of a blue outer ring and a yellow/orange inner ring, with radiating lines creating a sunburst effect. At the bottom right, the company's address is listed: 'One Campbell Plaza' and 'St. Louis, Missouri 63139'.

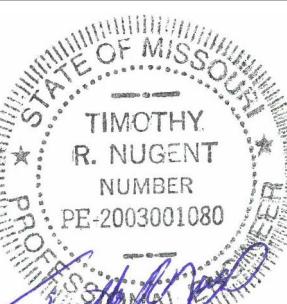

**RETAINING WALL NO. 2
COUNTY PROJECT NO. PW19135BXC
HEADS CREEK ROAD BRIDGE
JEFFERSON COUNTY, MISSOURI**

SECTION B-B

0	01/23/19	ISSUED FOR CONSTRUCTION	TRN
REV.	DATE	DESCRIPTION	APPROVED

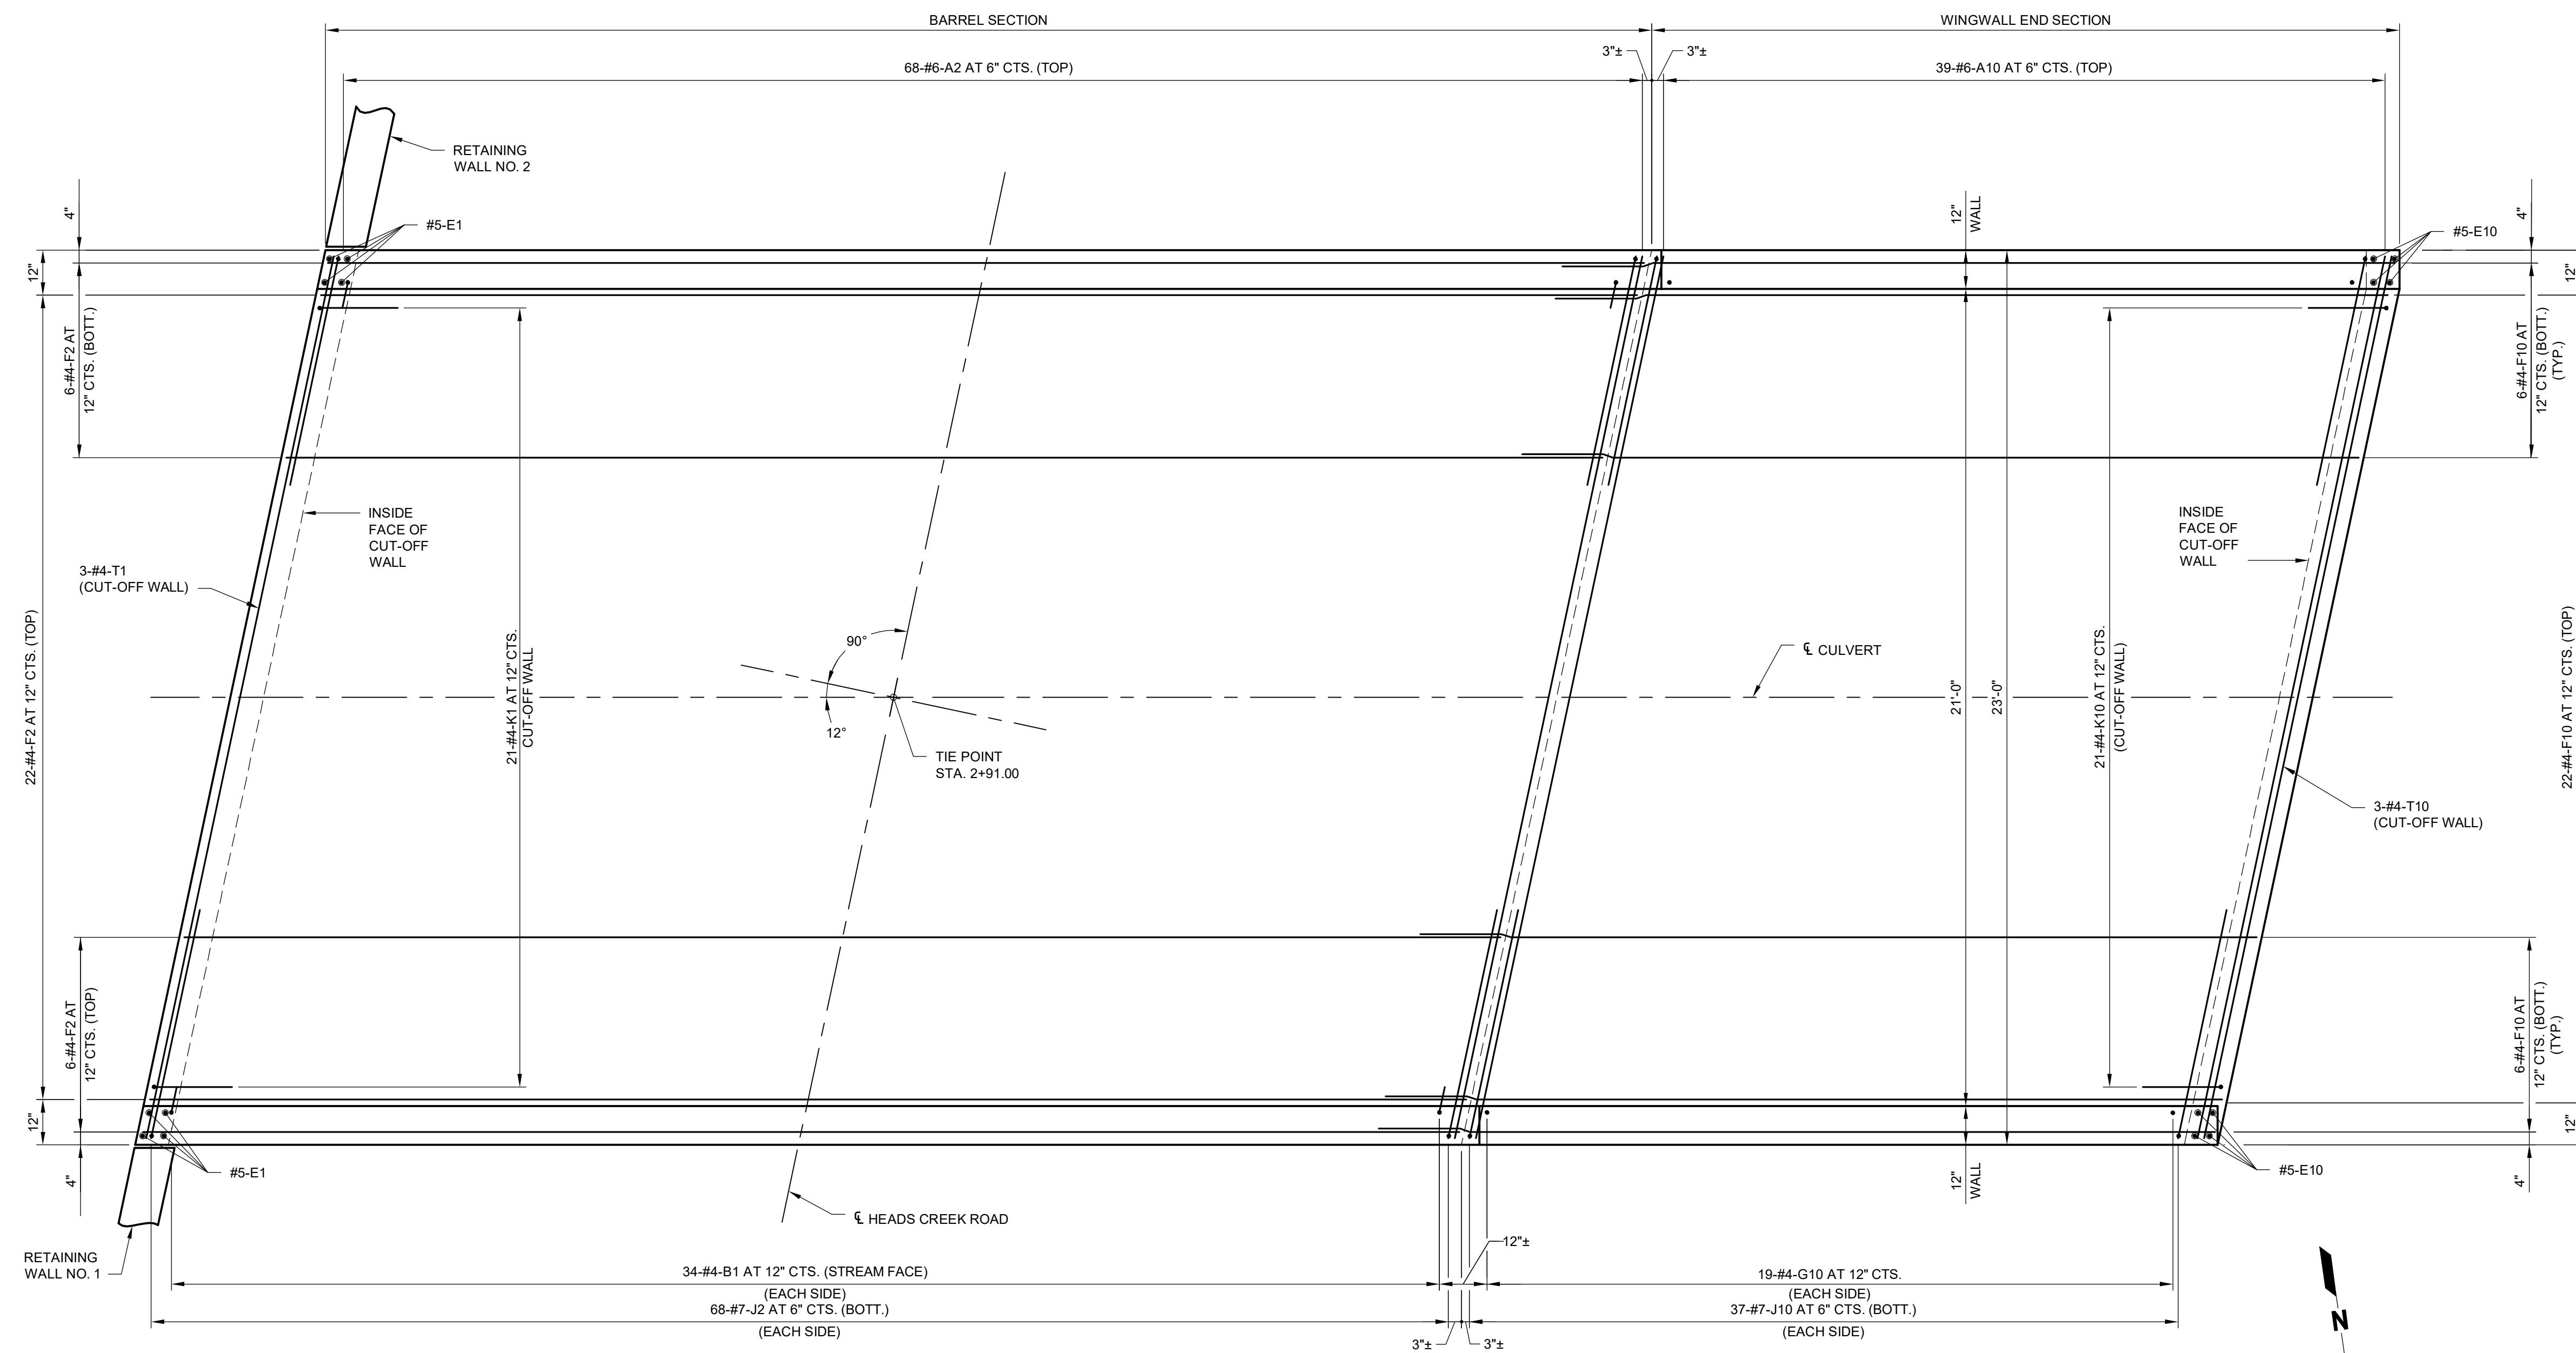

PLAN SHOWING BOTTOM SLAB REINFORCEMENT

NOTE: THIS DRAWING IS NOT TO SCALE. FOLLOW DIMENSIONS

PLOT SCALE FACTO


REV.	DATE	DESCRIPTION	APPROVED
0	01/23/19	ISSUED FOR CONSTRUCTION	TRN

CDG PROJECT NO.

18013


DRAWING NO.

B-106

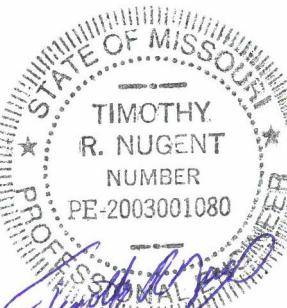

Tnugent
January 23, 2019

**CULVERT PLAN - BOTTOM SLAB REINFORCEMENT
COUNTY PROJECT NO. PW19135BXC
HEADS CREEK ROAD BRIDGE
JEFFERSON COUNTY, MISSOURI**

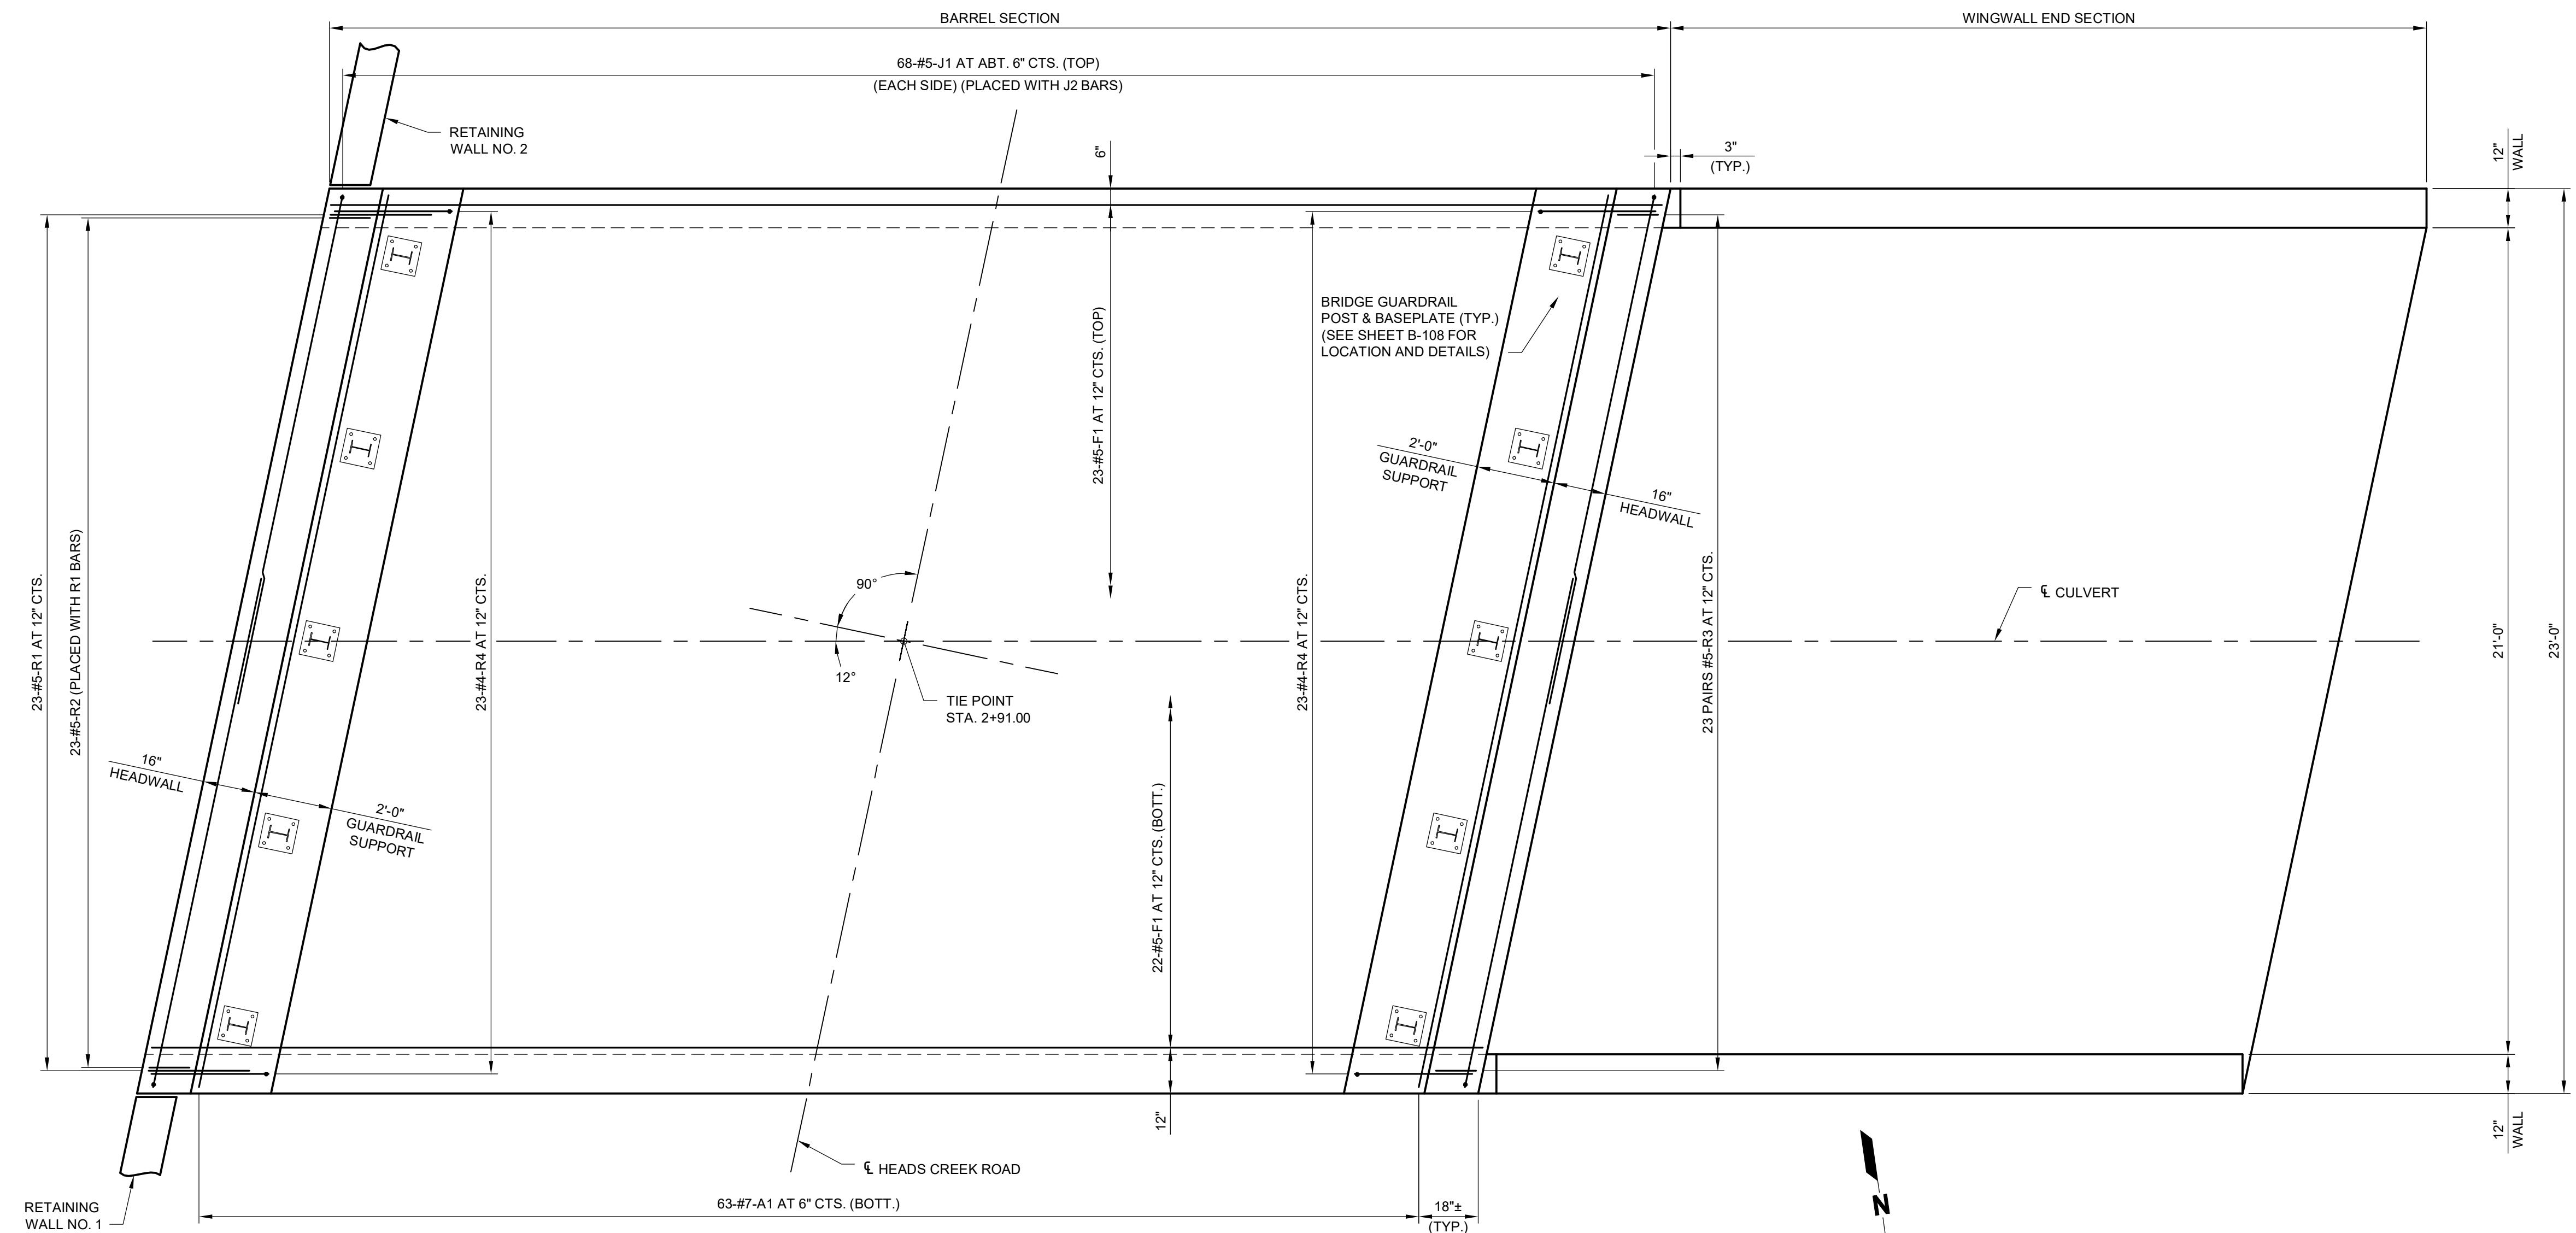

NOTE: THIS DRAWING IS NOT TO SCALE. FOLLOW DIMENSIONS.


PLOT SCALE FACTOR 1

REV.	DATE	DESCRIPTION	APPROVED
0	01/23/19	ISSUED FOR CONSTRUCTION	TRN

NOTES:
SEE DRAWING B-102 FOR SECTION THRU BOX CULVERT AND MISCELLANEOUS DETAILS.
SEE DRAWING B-103 FOR ELEVATION SHOWING WALL REINFORCEMENT AND SECTION THRU WINGWALL END SECTION.
SEE DRAWING B-103 FOR DETAILS AND REINFORCEMENT OF UPSTREAM AND DOWNSTREAM HEADWALLS AND GUARDRAIL SUPPORTS NOT SHOWN.
SEE DRAWING B-108 FOR GUARDRAIL POST LOCATIONS AND DETAILS.

CULVERT PLAN - TOP SLAB REINFORCEMENT
COUNTY PROJECT NO. PW19135BCX
HEADS CREEK ROAD BRIDGE
JEFFERSON COUNTY, MISSOURI


CDG PROJECT NO.
18013
DRAWING NO.
B-107

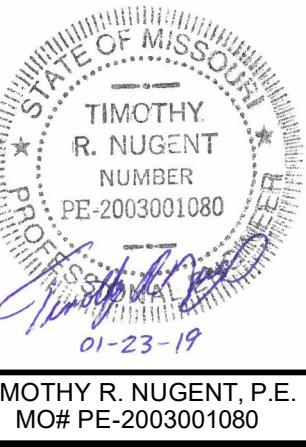

Trnugent
January 23, 2019

CDG
ENGINEERS
One Campbell Plaza
St. Louis, Missouri 63139
T. 314.781.7770
F. 314.781.8075

BILL OF REINFORCING STEEL																								
NO. REQ'D.	SIZE	MARK	LOCATION	EPOXY (E)	SHAPE NO.	STIRRUP (S)	SUBSTR. (X)	DIMENSIONS						WEIGHT										
								NO. EACH		B	C	D	E	WEIGHT										
								FT	IN	FT	IN	FT	IN	FT	IN	FT	IN	FT	IN	LBS				
REINFORCING STEEL (CULVERTS-BRIDGE)																								
			BARREL SECTION																					
63	7	A1	TOP SLAB	E	20			23	1	000					23	1	23	1	2972					
68	6	A2	BOTTOM SLAB			20		23	1	000					23	1	23	1	2358					
68	4	B1	BOTT SLAB / WALL	E	10					8.000	9	3.000				10	7	10	5	473				
4	8	D1	HEADWALL	E	20			23	1	000					23	1	23	1	247					
8	5	E1	CUT-OFF WALL			20		5	2	000					5	2	5	2	43					
45	5	F1	TOP SLAB	E	20			33	9	000					33	9	33	9	1584					
34	4	F2	BOTTOM SLAB			20		33	9	000					33	9	33	9	767					
28	4	F3	WALL			20		33	10	000					33	10	33	10	633					
6	8	H1	HEADWALL	E	20			23	1	000					23	1	23	1	370					
4	6	H2	HEADWALL	E	20			23	1	000					23	1	23	1	139					
6	4	H3	GRDRL SUPPORT	E	20			23	1	000					23	1	23	1	93					
136	5	J1	TOP SLAB / WALL	E	19			4	2	000	13	2.000			17	4	17	2	2435					
136	7	J2	BOTT SLAB / WALL		19			8	0.000	6	0.000				14	0	13	10	3845					
21	4	K1	CUT-OFF WALL		19	S		2	10.000	2	0.000				4	10	4	9	67					
23	5	R1	HEADWALL	E	27	S		1	0.000	1	5.625	5.000	2	0.000	3.625	3.625	4	11	4	9	114			
23	5	R2	HEADWALL	E	6	S		1	0.000	1	9.250	9.000			3	6	3	4	80					
46	5	R3	HEADWALL	E	10	S		1	0.000	2	2.750				4	3	4	0	192					
46	4	R4	GRDRL SUPPORT	E	19	S		1	3.000	2	11.000				4	2	4	1	125					
3	4	T1	CUT-OFF WALL		20			23	1	000					23	1	23	1	46					
REINFORCING STEEL (CULVERTS-BRIDGE) - SUBTOTAL														7759										
REINFORCING STEEL (EPOXY COATED) - SUBTOTAL														8824										
WINGWALL END SECTION																								
39	6	A10	BOTTOM SLAB		20			23	1	000					23	1	23	1	1352					
8	5	E10	CUT-OFF WALL		20			4	0.000						4	0	4	0	33					
34	4	F10	BOTT SLAB		20			21	6.000						21	6	21	6	488					
4	4	F11	WALL		20			21	6.000						21	6	21	6	57					
28	4	F12	WALL		20			6	0.000						6	0	6	0						
			INCR = 28"			V	4	20.000							20	0	20	0	243					
38	4	G10	BOTT SLAB/WALL		20			2	5.000						2	5	2	5						
			INCR = 5.125"			V	2	10.1250							10	1	10	1	159					
74	7	J10	BOTT SLAB / WALL		19			2	5.000	6	0.000				8	5	8	3						
			INCR = 2.5625"			V	2	10.1250	6	0.000					16	1	15	11	1828					
8	7	J11	WALL		14			20	4.000	3	9.000				1	5.625	3	5.375	24	1	24	1	394	
21	4	K10	CUT-OFF WALL		19			2	10.000	2	0.000				4	10	4	9	67					
3	4	T10	CUT-OFF WALL		20			23	1	000					23	1	23	1	46					
REINFORCING STEEL (CULVERTS-BRIDGE) - SUBTOTAL														4667										
REINFORCING STEEL (EPOXY COATED) - SUBTOTAL														0										
REINFORCING STEEL (CULVERTS-BRIDGE) - TOTAL														12426										
REINFORCING STEEL (EPOXY COATED) - TOTAL														8824										
REINFORCING STEEL (CULVERTS-BRIDGE) - SUBTOTAL																								
REINFORCING STEEL (EPOXY COATED) - SUBTOTAL																								
REINFORCING STEEL (CULVERTS-BRIDGE) - TOTAL																								
REINFORCING STEEL (EPOXY COATED) - TOTAL																								

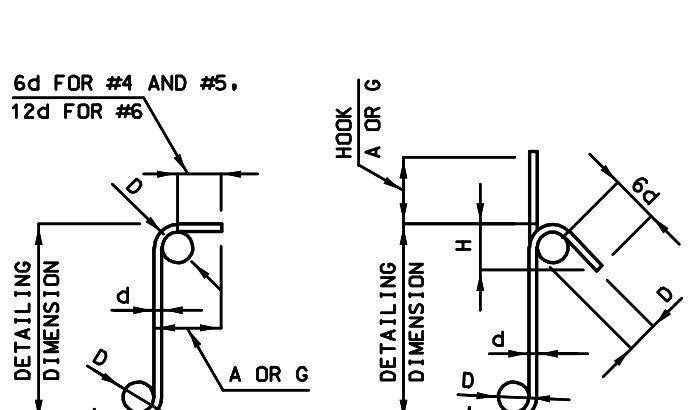

STIRRUP HOOK DIMENSIONS
GRADES 40 - 50 - 60 KSI
BAR SIZE (IN.) D 90° HOOK 135° HOOK
#4 2" 4 1/2" 4 1/2" 3"
#5 2 1/2" 6" 5 1/2" 3 3/4"
#6 4 1/2" 12" 8" 4 1/2"
NOTE: UN